## Airports Division


DEPARTMENT OF TRANSPORTATION STATE OF HAWAII

PLANS FOR

# MINOR REPAIR AT VIDEO ROOM, HNL

HONOLULU INTERNATIONAL AIRPORT HONOLULU, HAWAII

STATE PROJECT NO. C01630-33

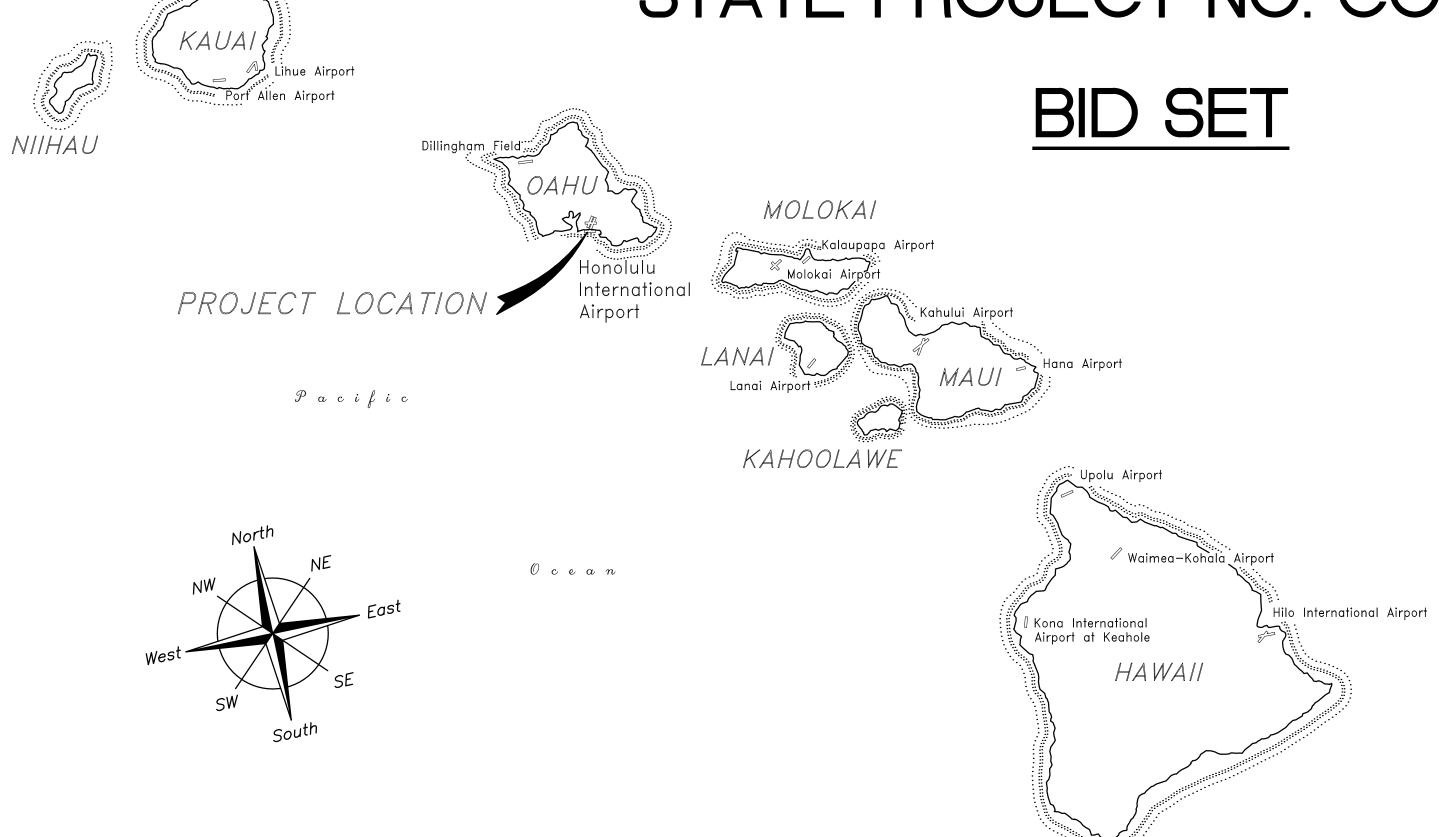

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		KEY PLAN / NOTES :
		PROJECT LOCATION
		NO.: DATE: REVISIONS:
		PROJECT TITLE :
		MINOR REPAIR
		AT VIDEO ROOM, HNL
		HONOLULU INTERNATIONAL
		AIRPORT HONOLULU, HAWAII

DEPARTMENT OF TRANSPORTATION

STATE OF HAWAII

DIRECTOR OF TRANSPORTATION

APPROVED:

PROJECT NO.:


STATE PROJECT NO. CO1630-33

SHEET TITLE :


TITLE SHEET, PROJECT LOCATION, INDEX TO DRAWINGS


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DWG.	NO.:		
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T-1

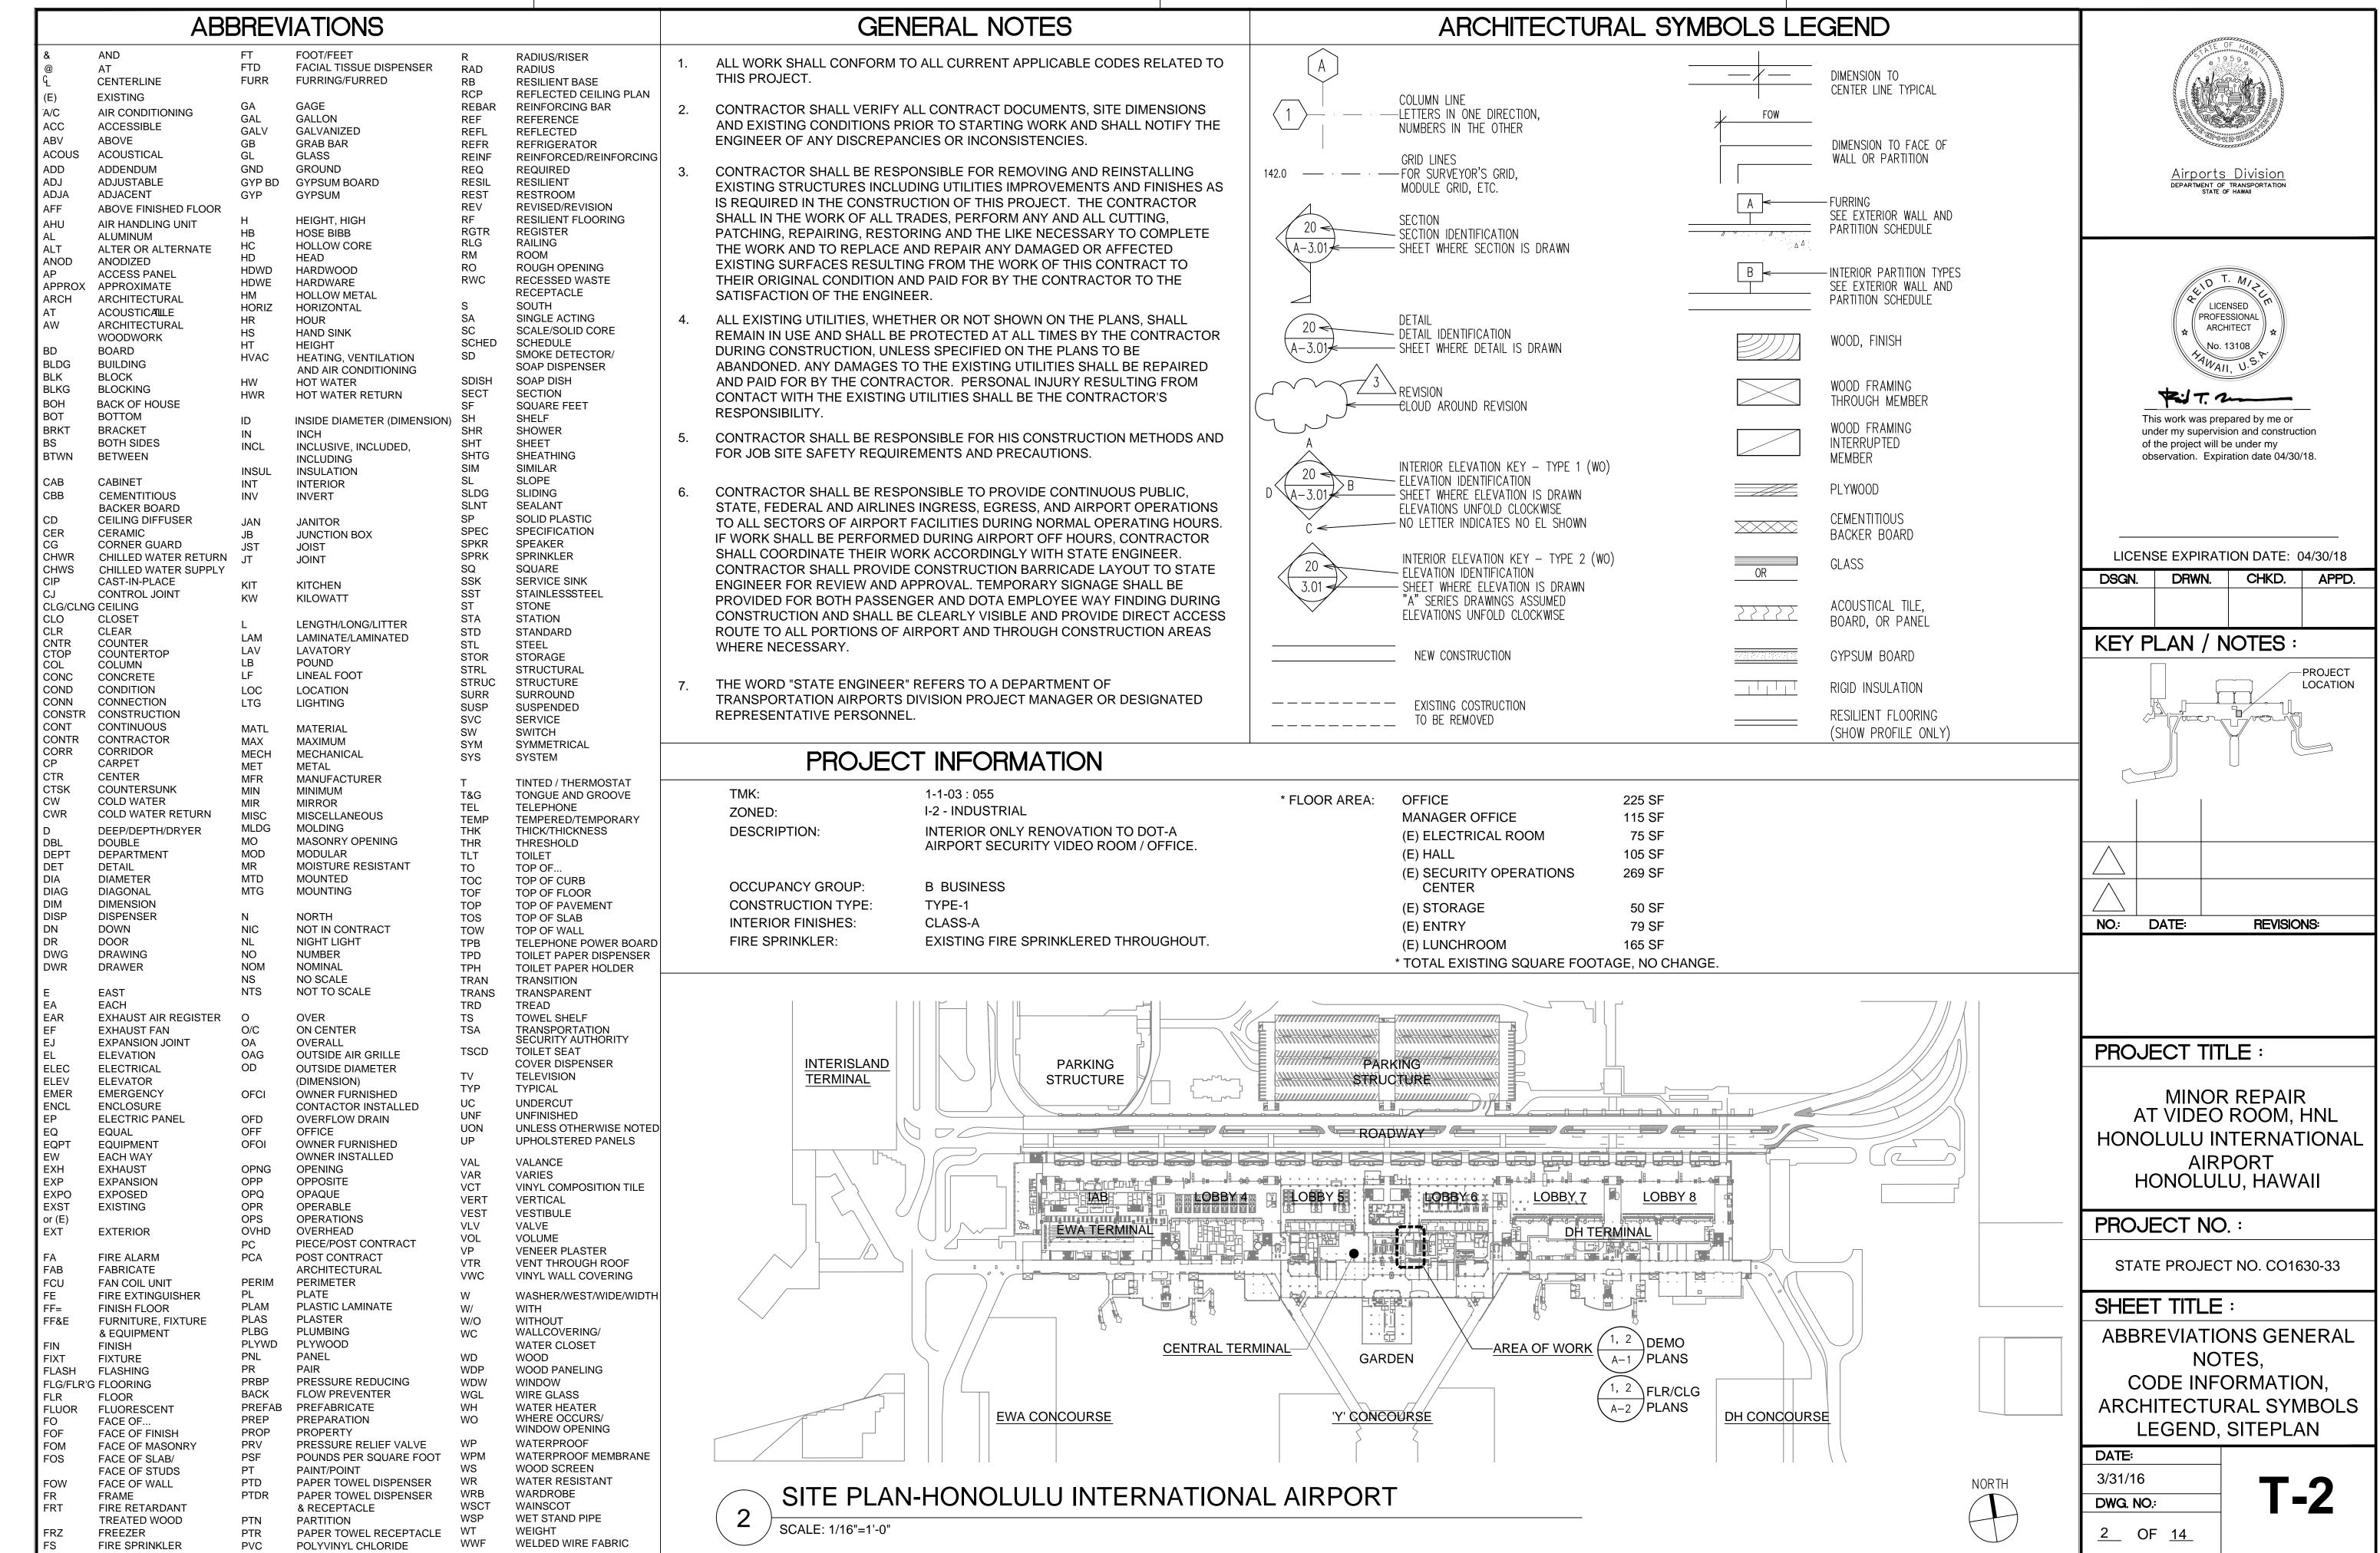



CO1630-33 - BID SET




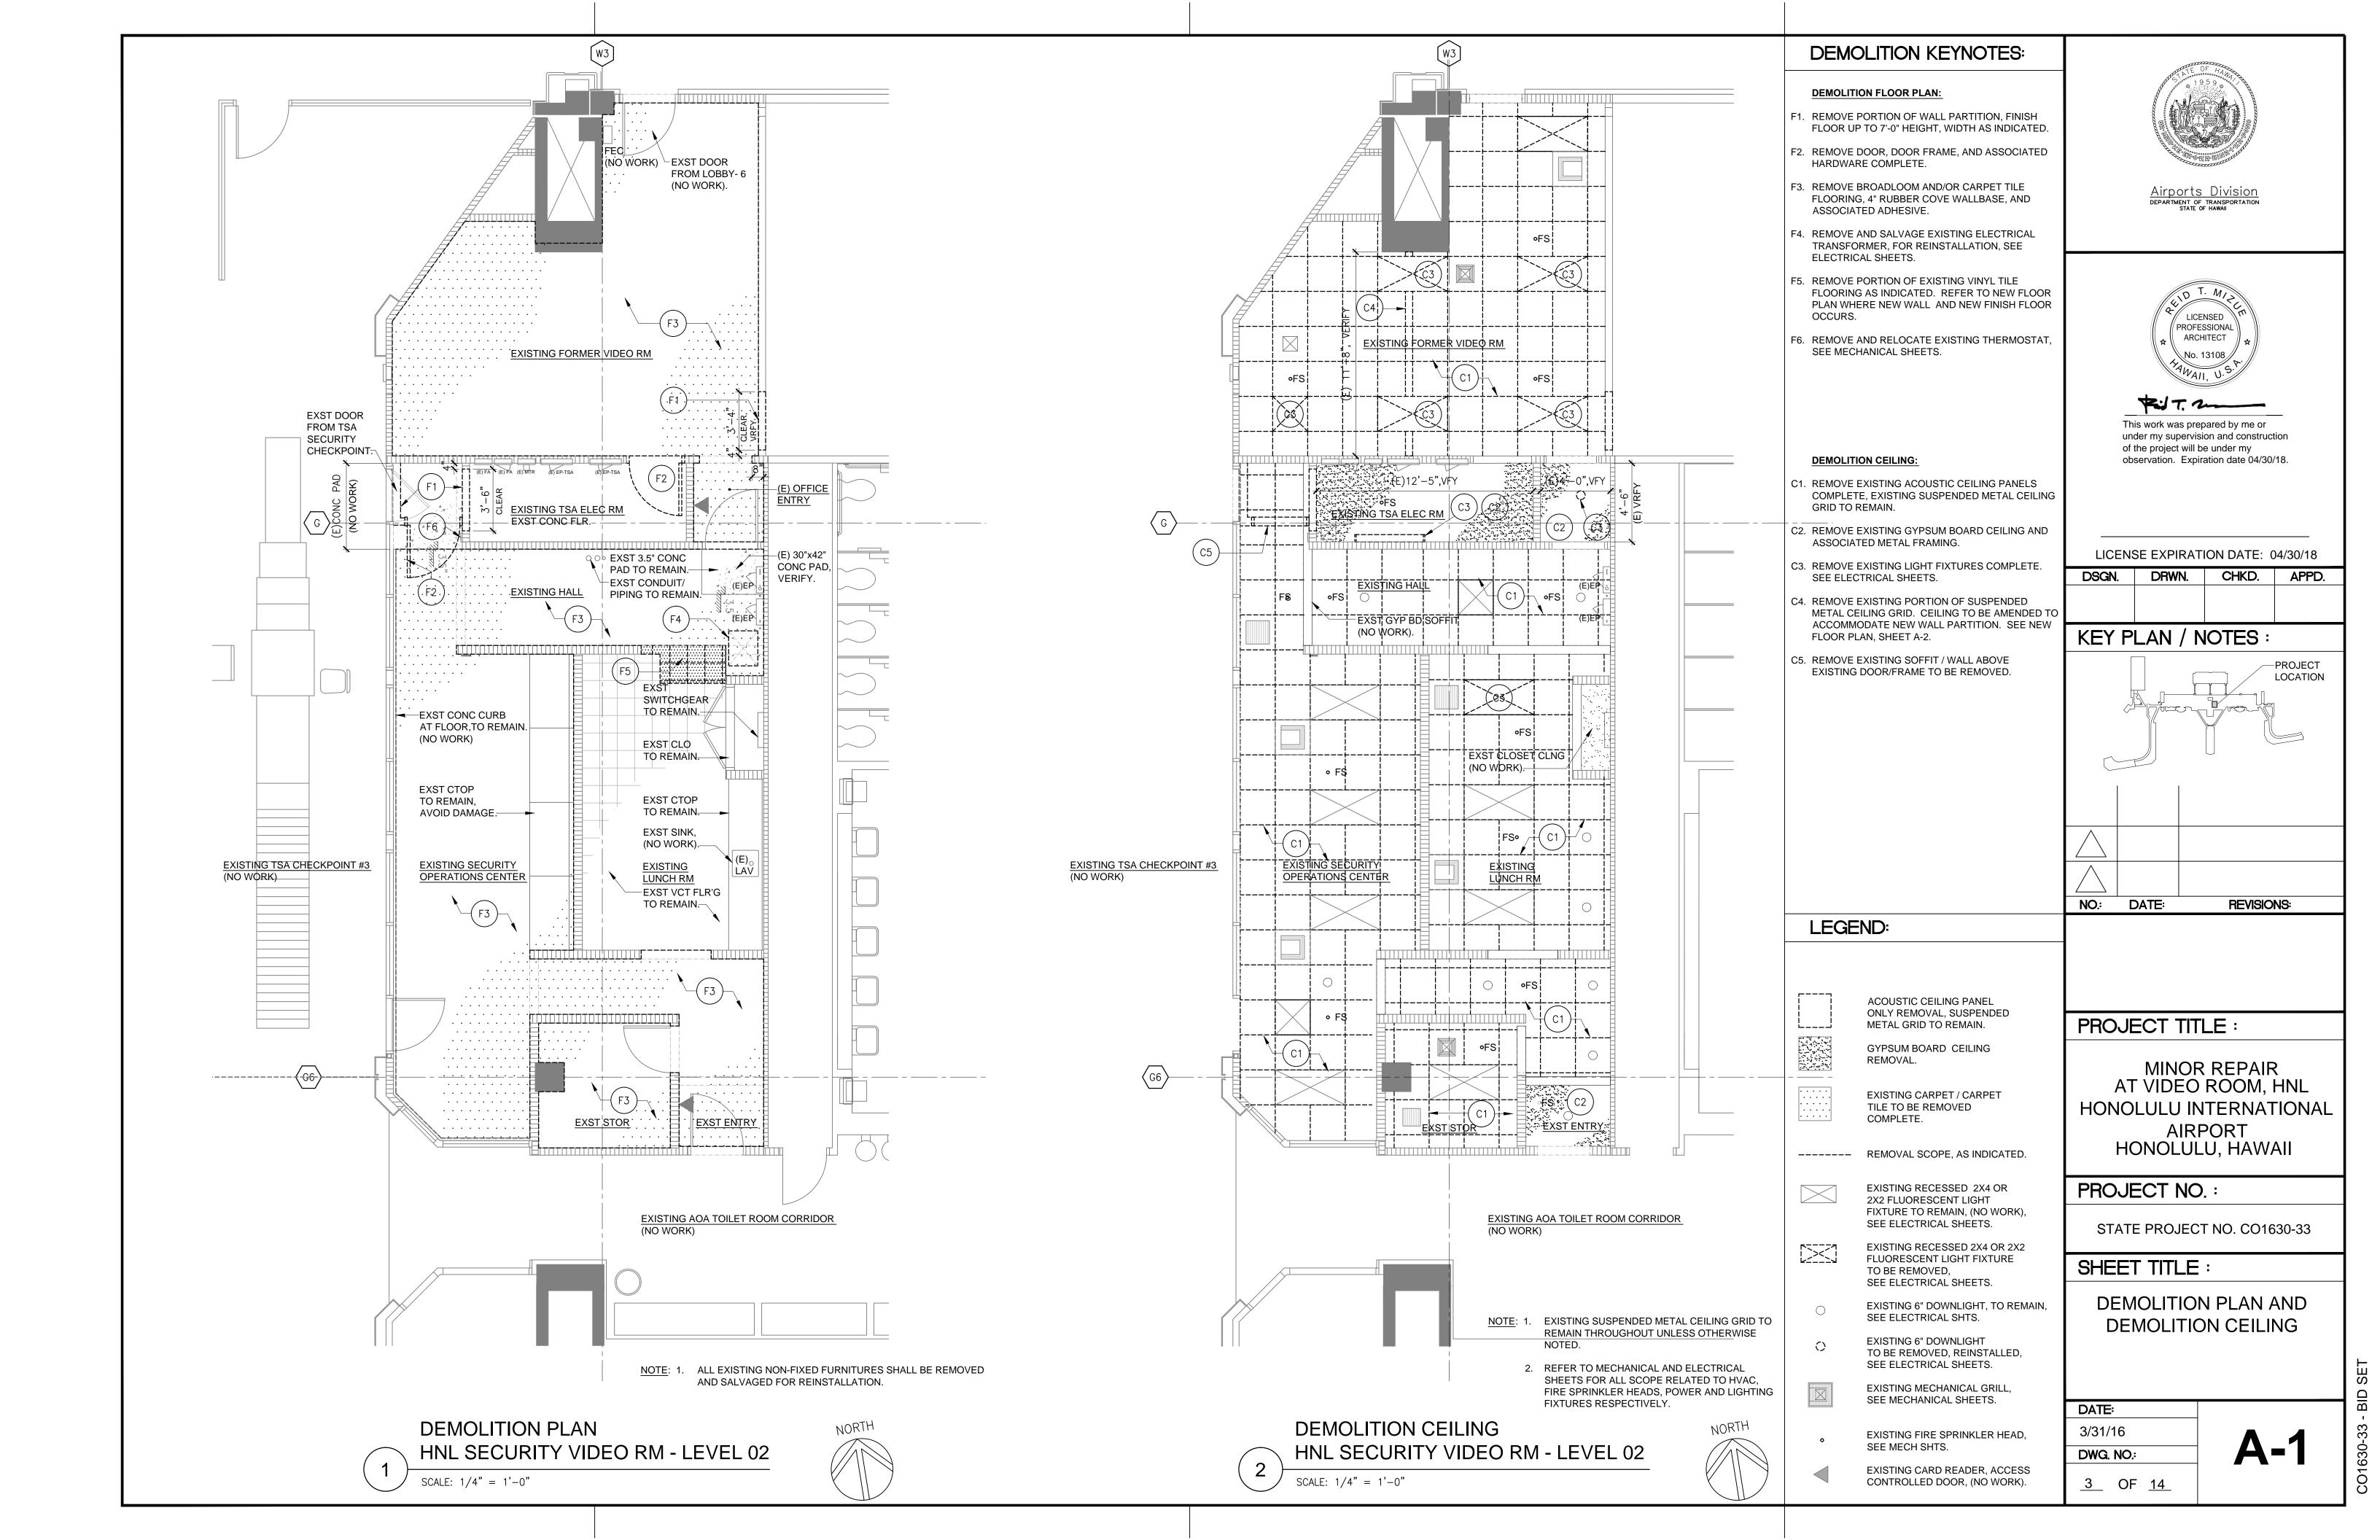


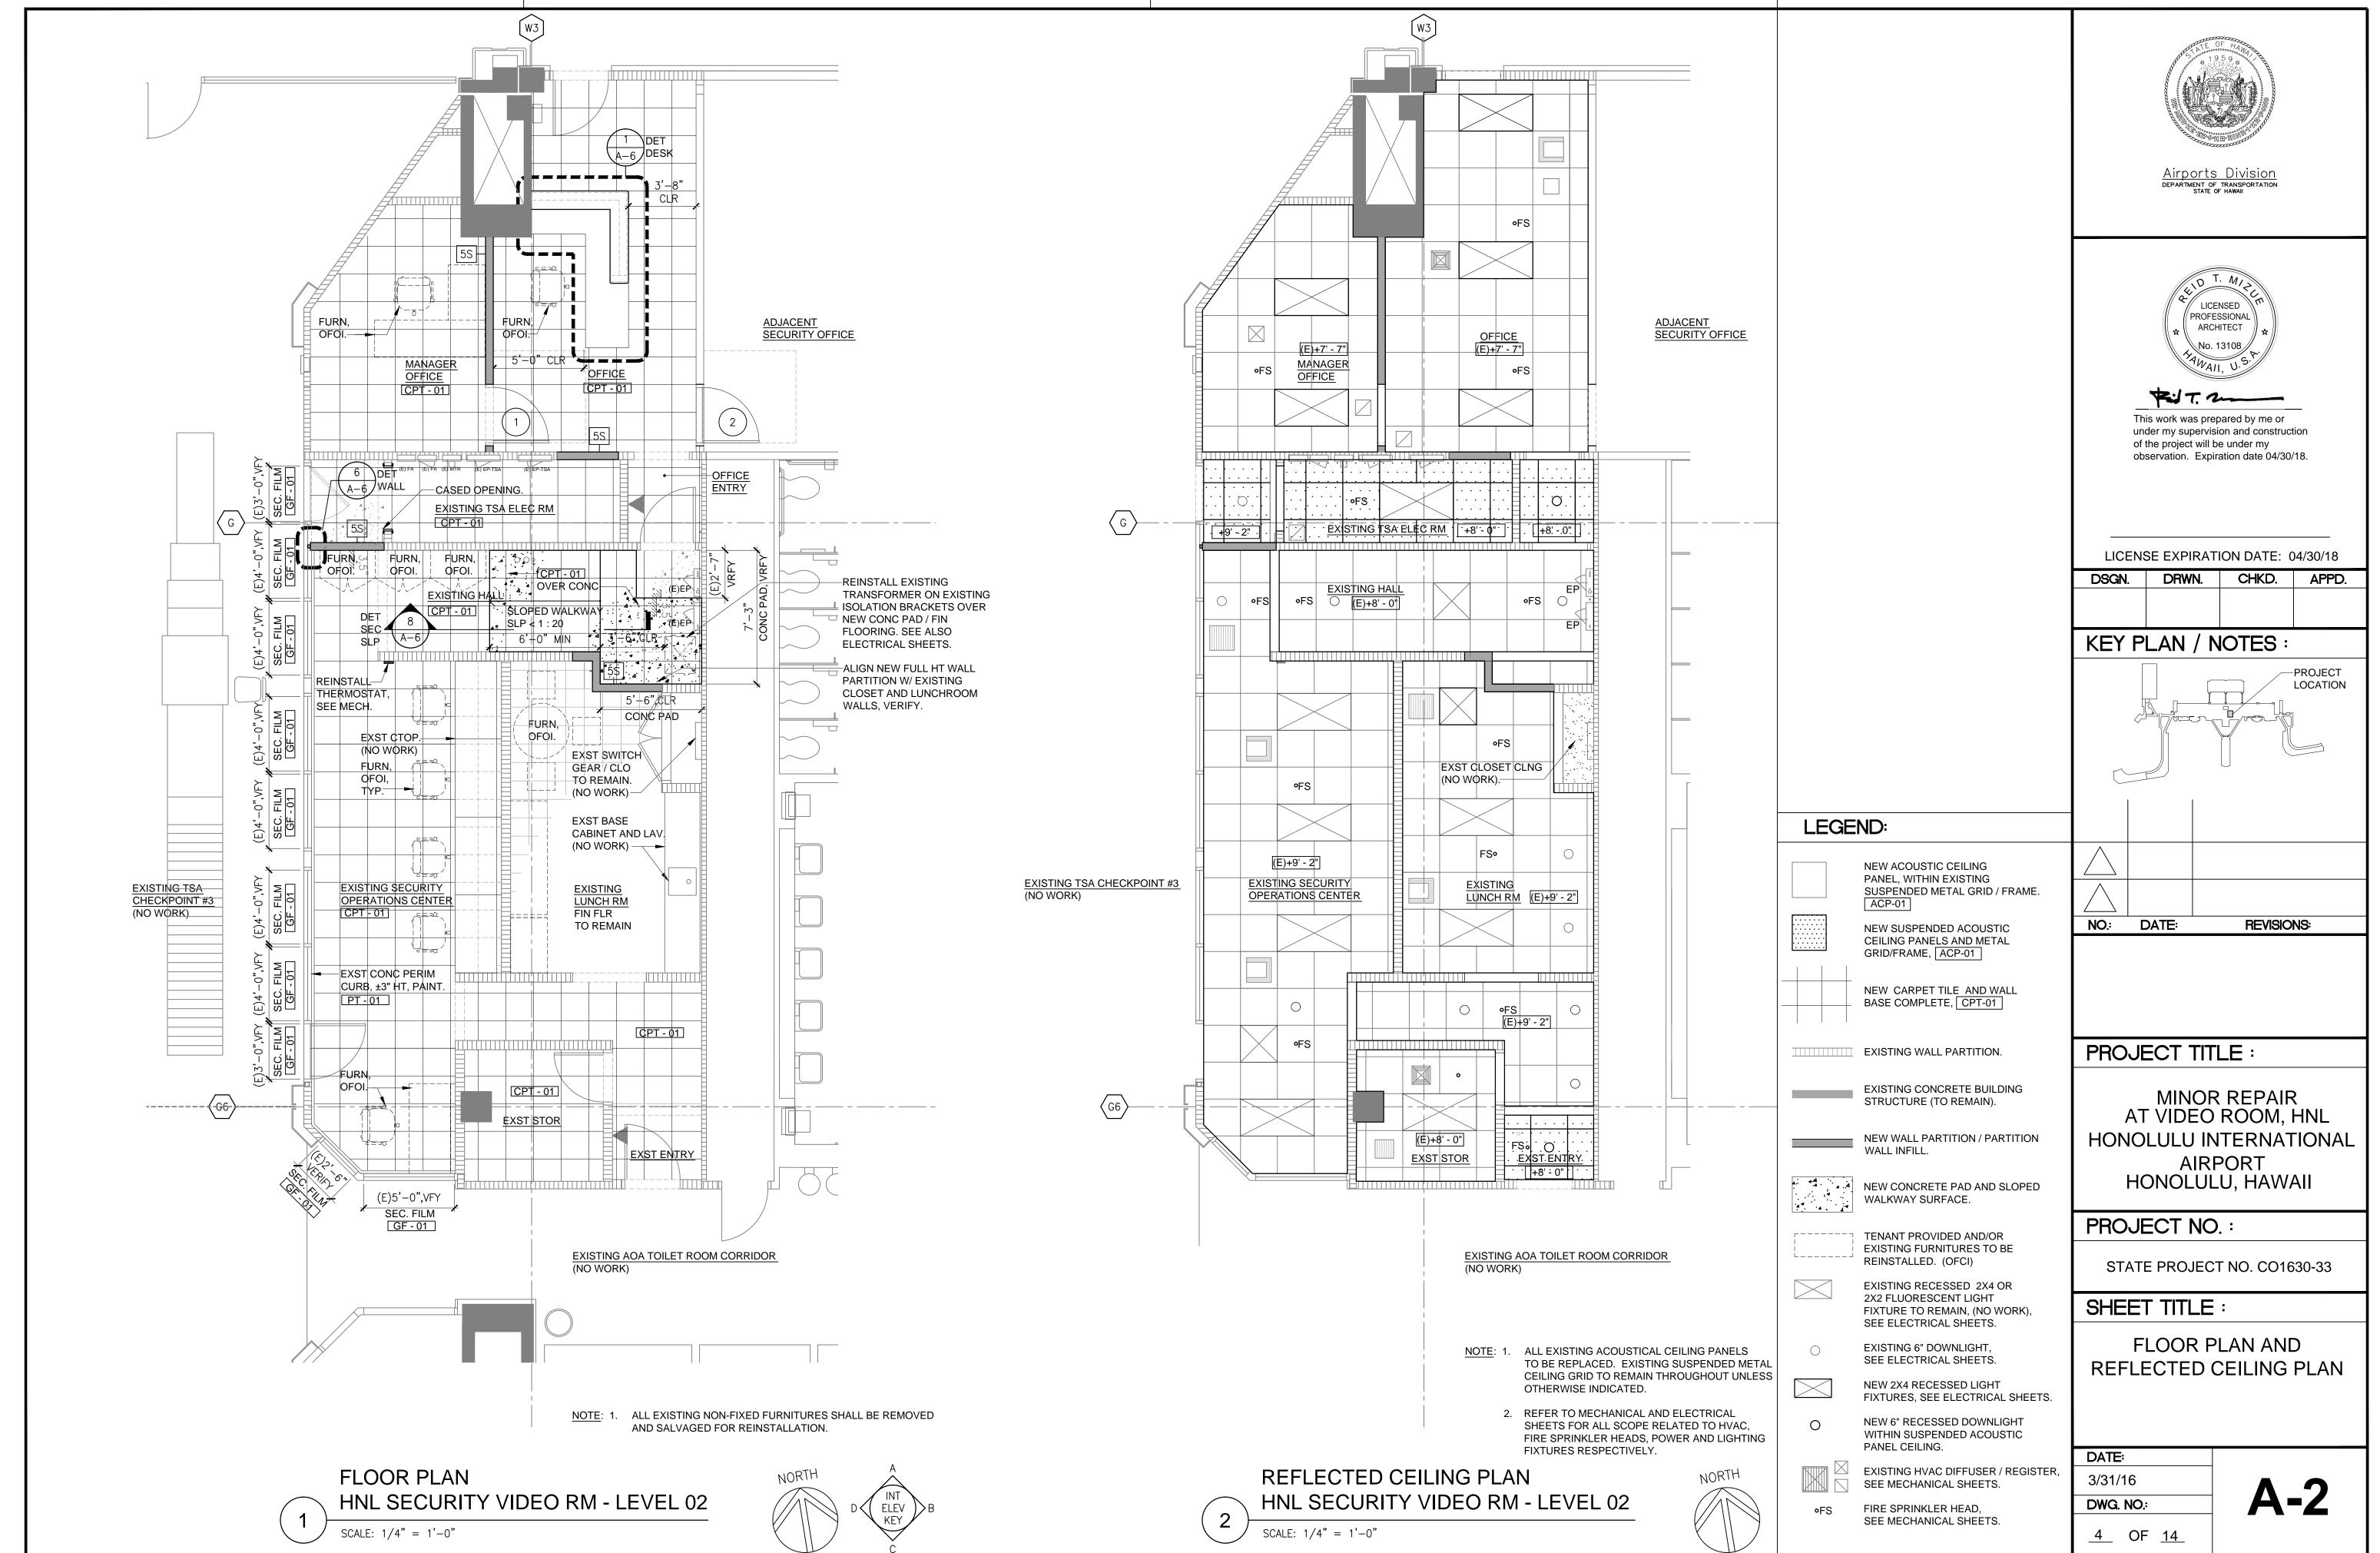CO1630-33 - BID SET

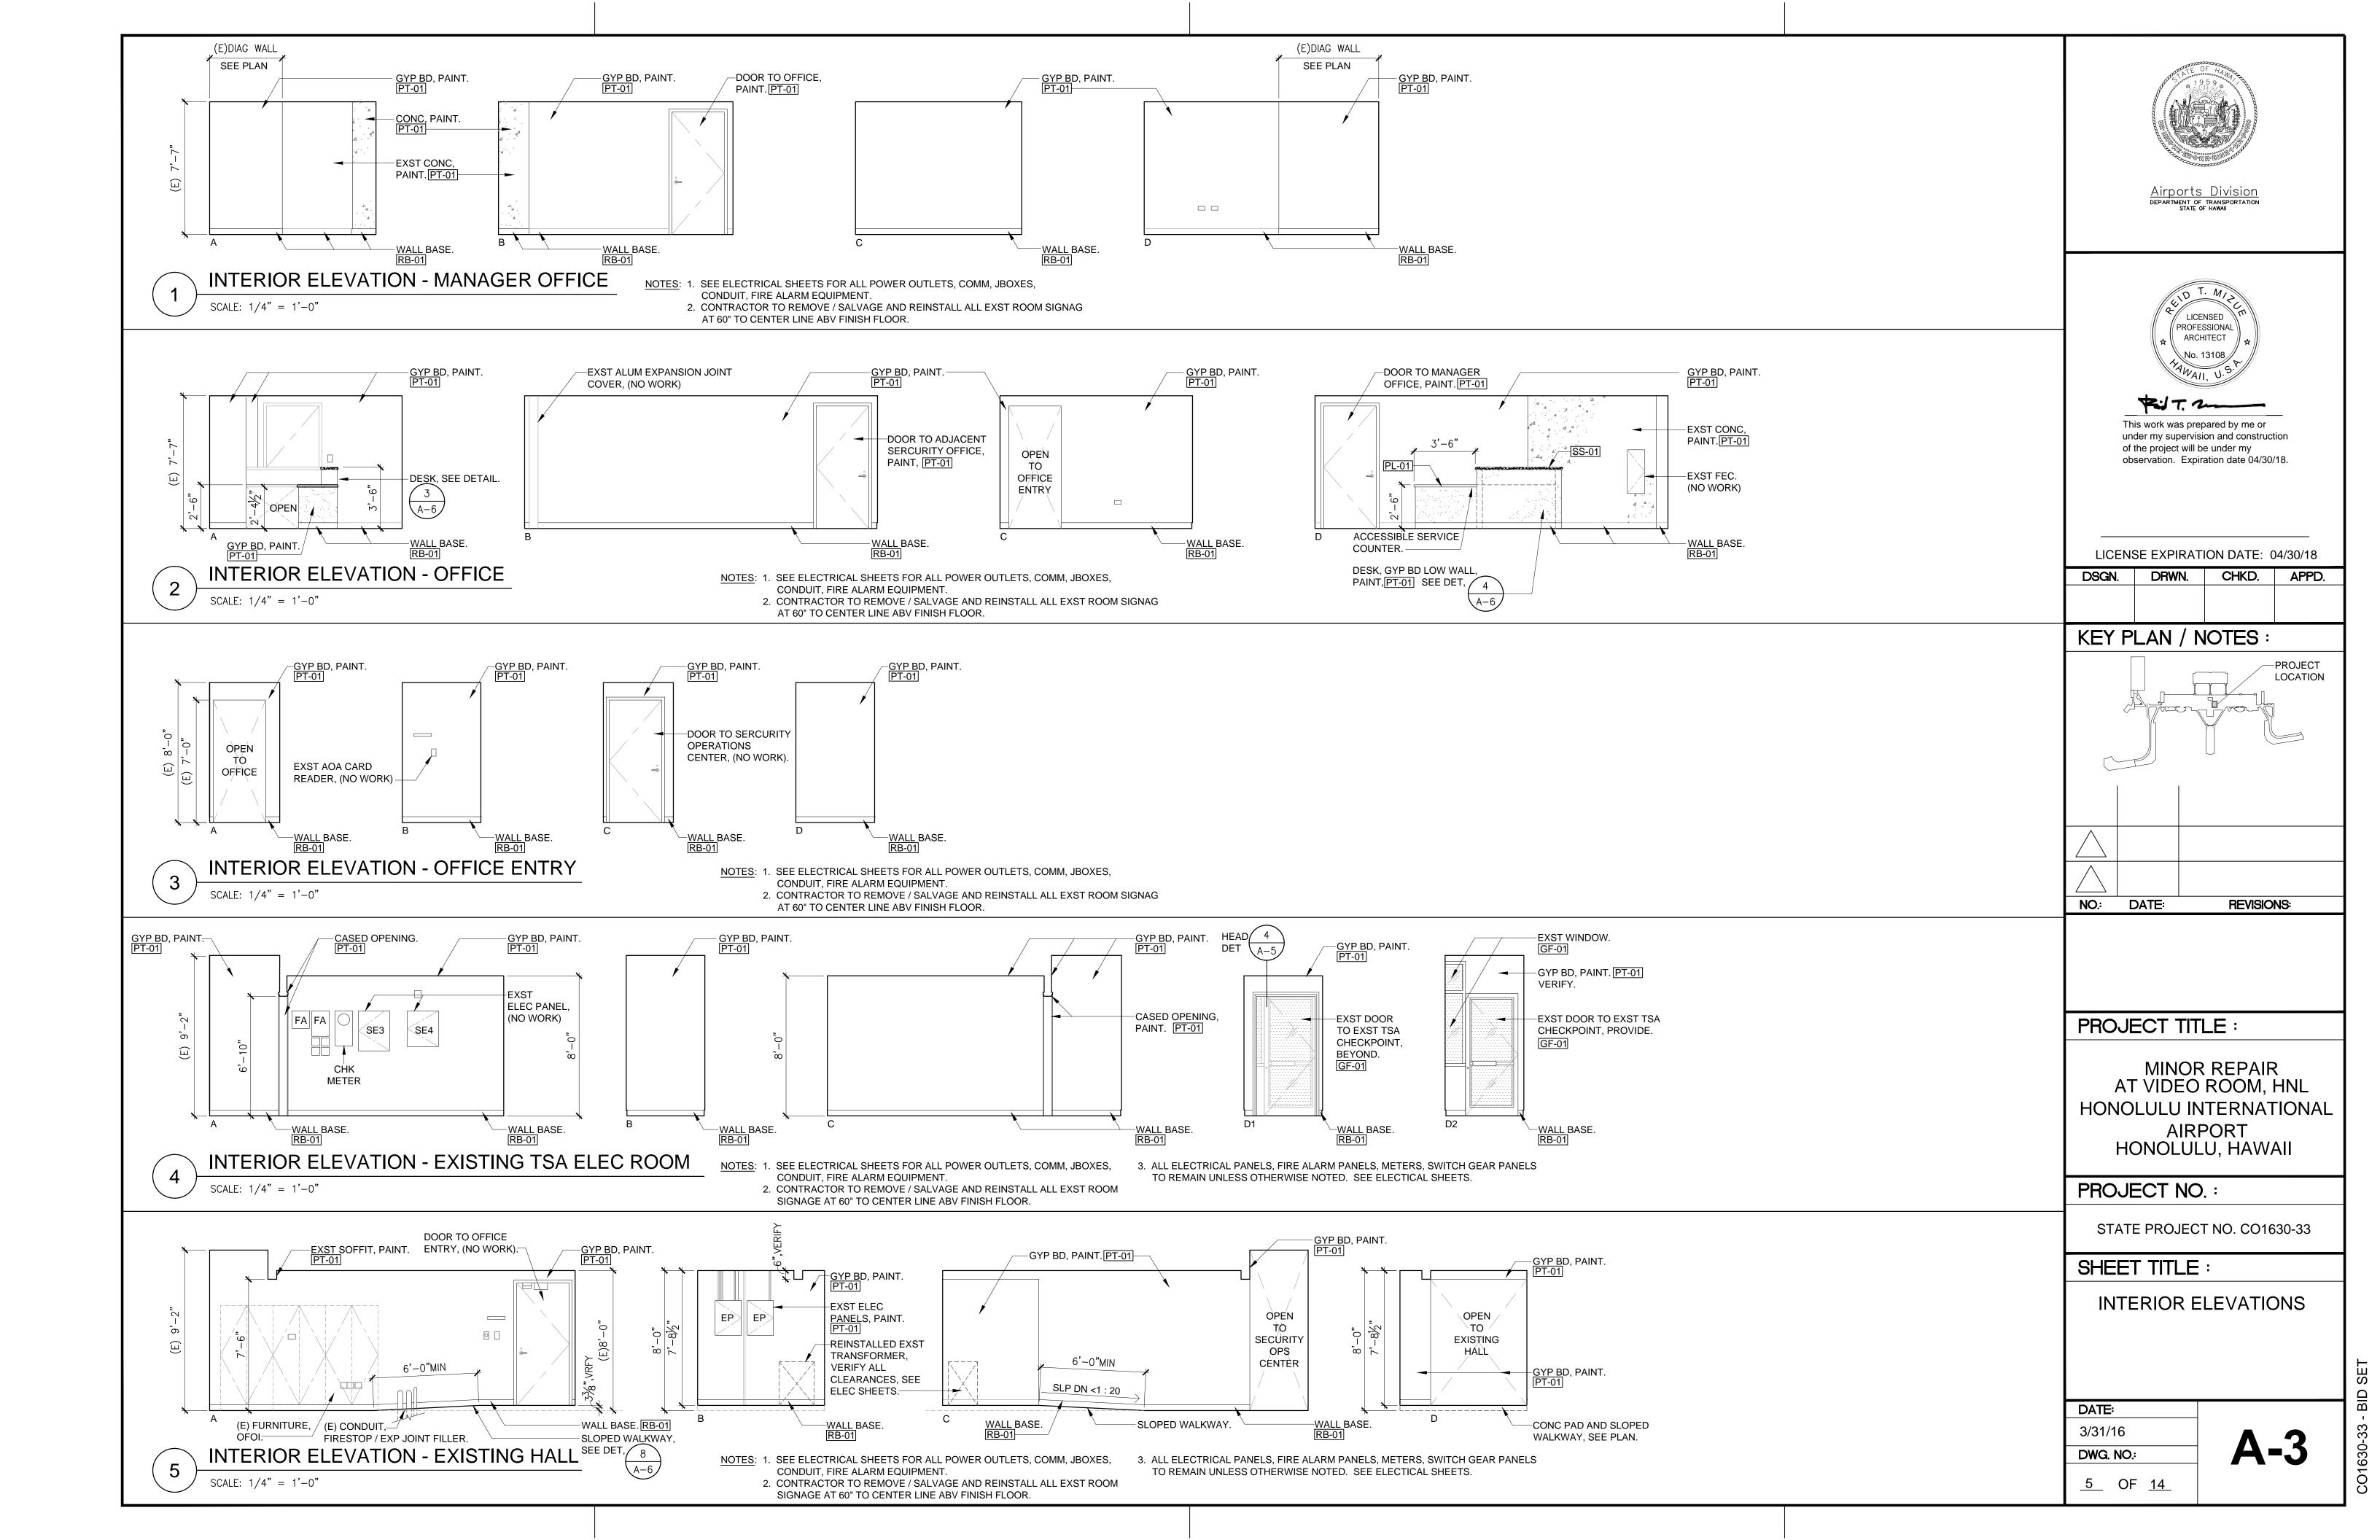

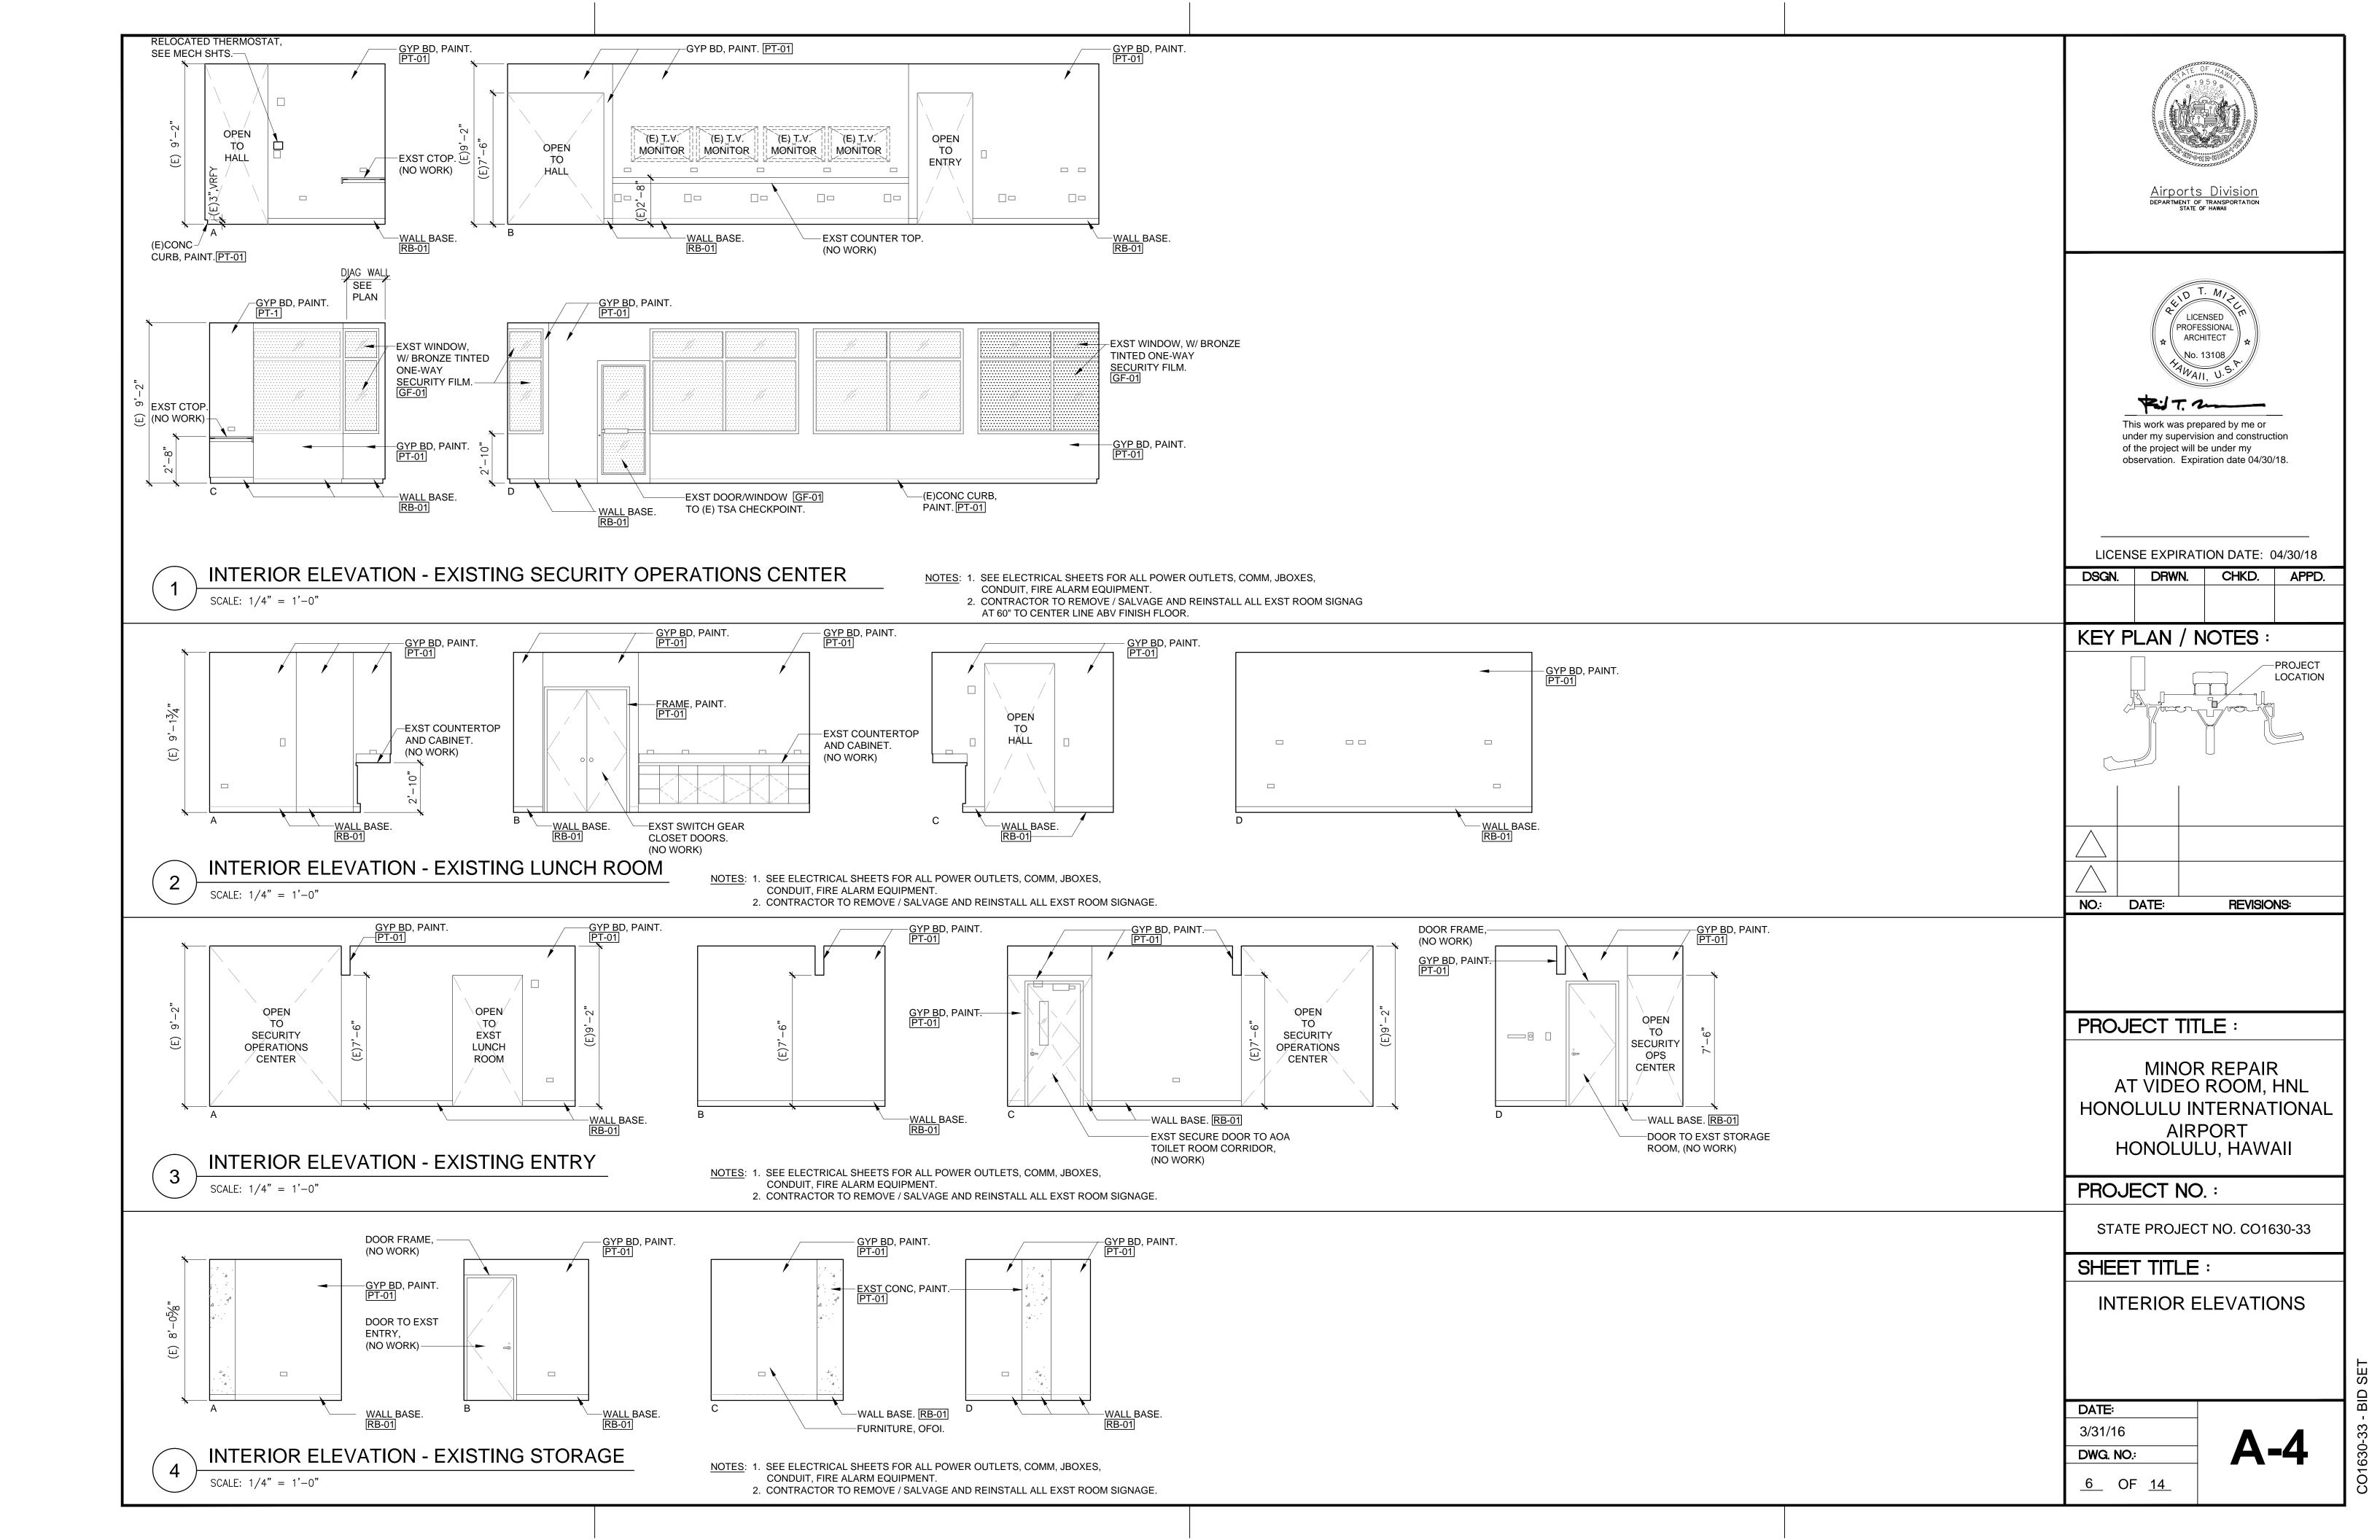

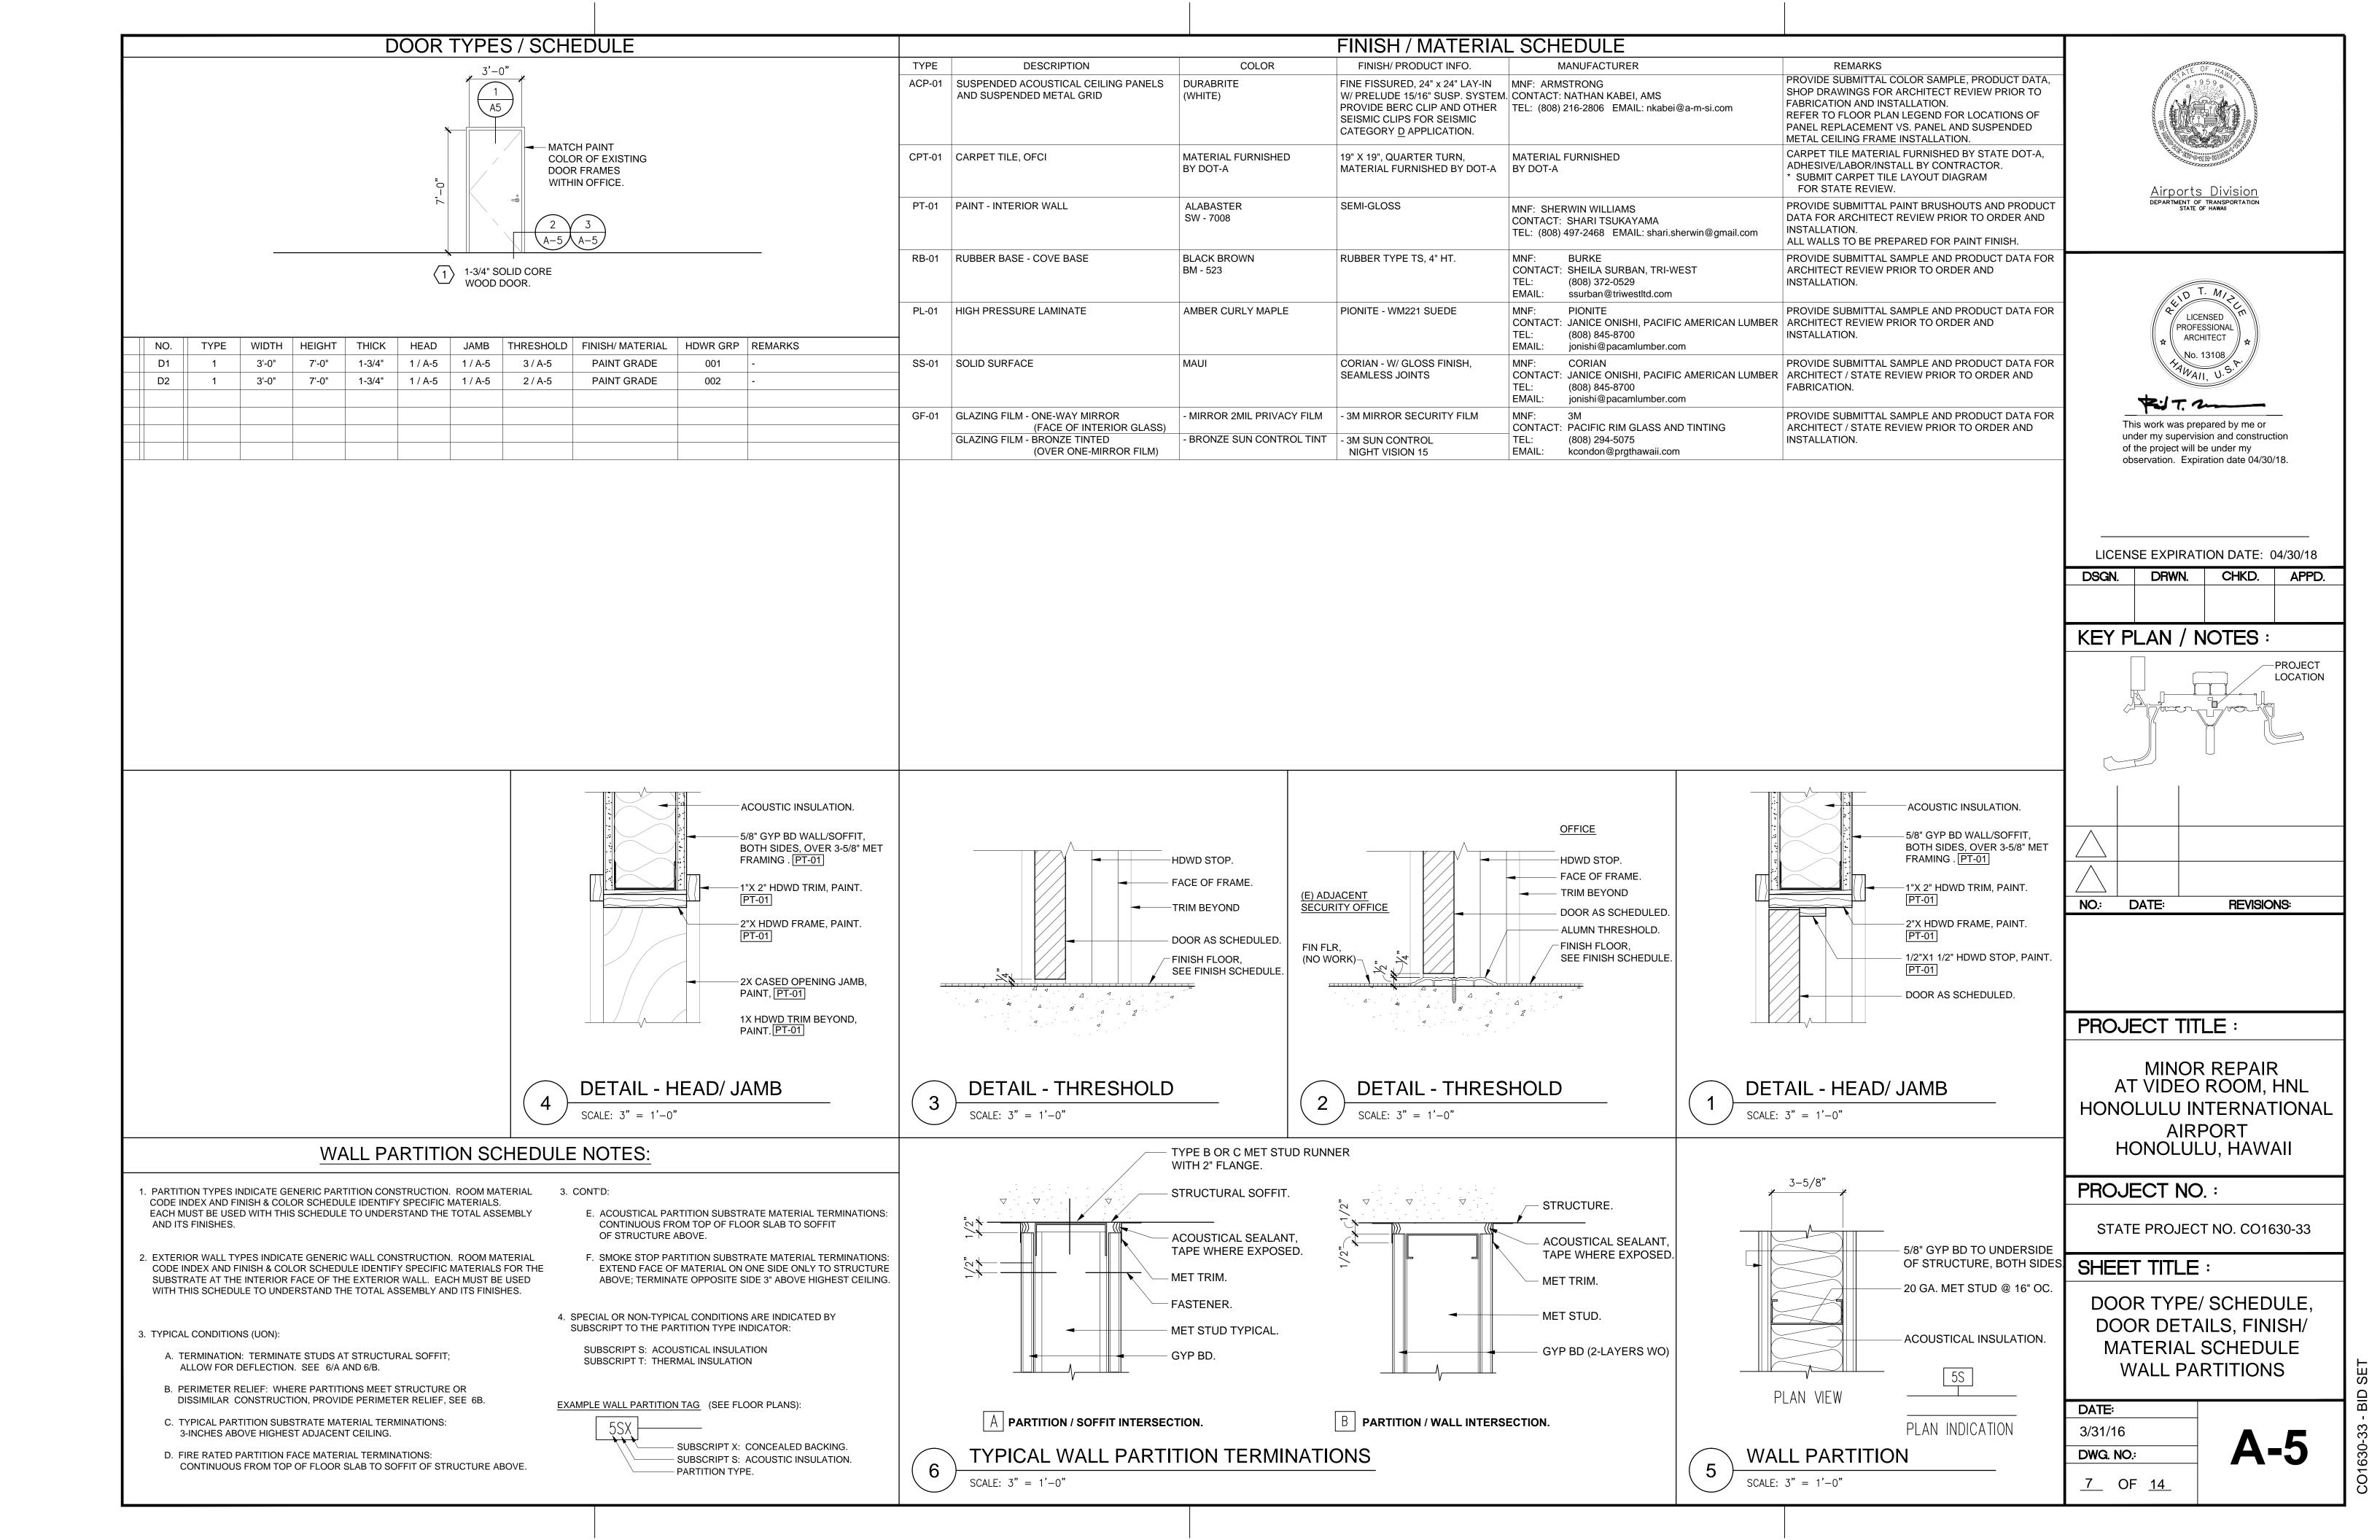

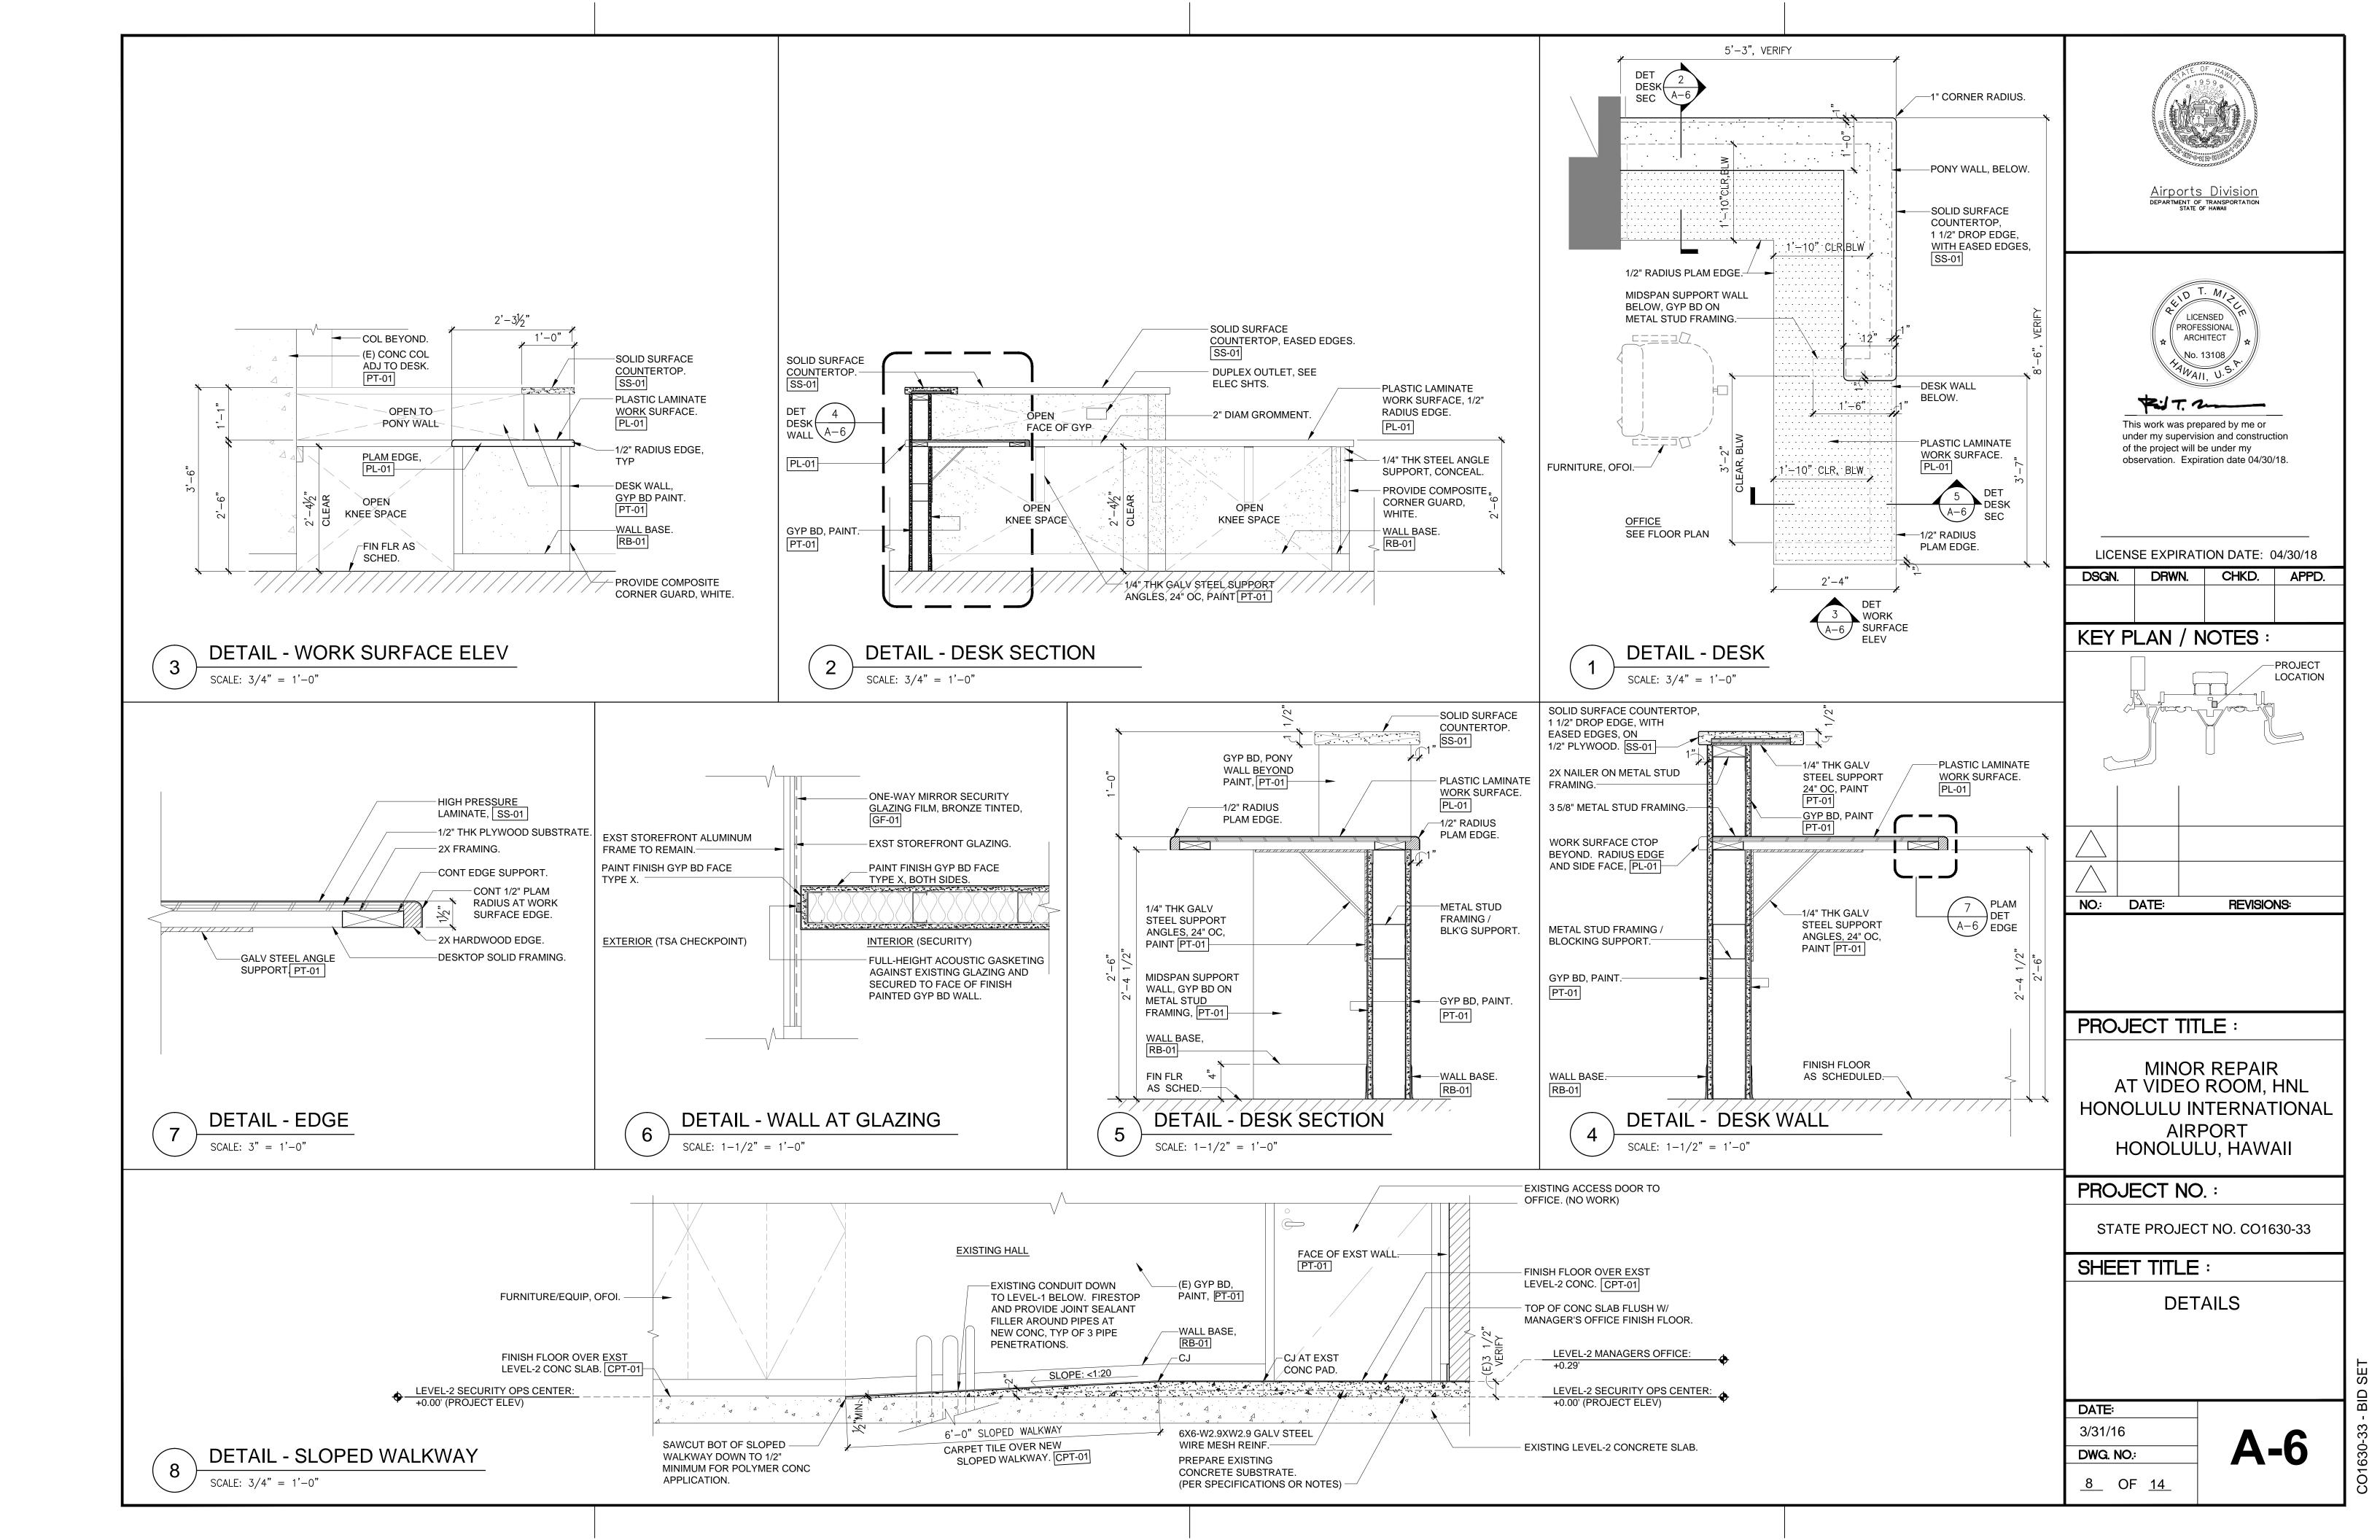

#### **GENERAL NOTES:**

- 1. CONSTRUCTION DOCUMENTS CONSIST OF DESIGN DRAWINGS (DWG) AND WRITTEN SPECIFICATIONS (SPEC). WHEREVER DISCREPANCIES OR CONFLICTS ARE FOUND BETWEEN DWG AND SPEC, THE MORE STRINGENT REQUIREMENTS/CRITERIA SHALL GOVERN.
- 2. ALL WORK SHOWN ON THESE DRAWINGS ARE NEW UNLESS OTHERWISE
- 3. EXISTING CONDITIONS AND DIMENSIONS SHOWN ON THESE DRAWINGS ARE APPROXIMATE PRIOR TO ORDERING MATERIALS AND PROCURING EQUIPMENT, SUCCESSFUL BIDDER (CONTRACTOR) SHALL BE REQUIRED TO VERIFY ALL EXISTING CONDITIONS, INCLUDING BUT NOT LIMITED TO EQUIPMENT, MATERIALS, SIZES, DIMENSIONS, INVERTS, AND VOLTAGES THAT AFFECT HIS WORK. SUBMIT A LETTER TO THE ENGINEER CONFIRMING THAT THIS WAS DONE. IF WRITTEN CONFIRMATION IS NOT RECEIVED BY THE ENGINEER, SHOP DRAWINGS AND OTHER SUBMITTALS WILL BE RETURNED WITHOUT REVIEW. SHOW ALL DISCREPANCIES ON SHOP DRAWINGS AND NOTIFY THE ENGINEER IN WRITING OF SUCH DISCREPANCIES PRIOR TO PROCUREMENT.
- 4. ALL UTILITIES AND APPURTENANCES SHALL BE PROTECTED AT ALL TIMES DURING CONSTRUCTION. AND IF DAMAGED, SHALL BE REPAIRED BY THE CONTRACTOR AT NO COST TO THE GOVERNMENT.
- 5. CAP AND REMOVE ALL UNUSED PIPING, DO NOT ABANDON IN PLACE.
- 6. THIS CONTRACT REQUIRES THE PLUMBING, FIRE PROTECTION, AND MECHANICAL SUBCONTRACTORS TO CAREFULLY COORDINATE THEIR WORK WITH EACH OTHER, THE GENERAL CONTRACTOR AND OTHER TRADES. PRIORITY SHALL BE GIVEN IN THE FOLLOWING ORDER:
- A. GRAVITY FLOW: CONDENSATE DRAIN PIPING.
- B. EQUIPMENT AND DUCTWORK.
- C. FORCED AND PRESSURE PIPING SUCH AS WATER PIPING.
- 7. CONTRACTOR SHALL PROVIDE DIELECTRIC UNIONS AT CONNECTION POINTS FOR PIPING OF DISSIMILAR METALS.
- 8. FOR ALL WALL PARTITION AND CEILING PENETRATIONS, SEE ARCHITECTURAL DRAWINGS FOR DETAILS.
- 9. NO CUTTING OR DRILLING OF ANY STRUCTURAL MEMBERS WILL BE PERMITTED WITHOUT THE APPROVAL OF THE STRUCTURAL ENGINEER
- 10. ALL FASTENERS, SUPPORTS, PIPE HANGERS, SPRING ISOLATORS, AND MISCELLANEOUS STEEL ITEMS INCLUDING BUT NOT LIMITED TO BOLTS. NUTS. SCREWS, RODS, PLATES, AND ANGLES, ETC. SHALL BE GALVANIZED UNLESS OTHERWISE NOTED OR SPECIFIED.
- 11. PROVIDE ACCESS PANELS IN NON-ACCESSIBLE CEILINGS FOR ALL MECHANICAL ITEMS REQUIRING SERVICING AND MAINTENANCE INCLUDING BUT NOT LIMITED TO: VOLUME DAMPERS, FIRE/SMOKE DAMPERS, FIRE DAMPERS, CONDENSATE DRAINS, VALVES, ETC. PROVIDE FIRE-RATED ACCESS PANELS AS REQUIRED. COORDINATE TYPE OF ACCESS PANEL WITH WALL OR CEILING CONTRACTOR. ACCESS PANELS SHALL BE 30"x30" MINIMUM UNLESS OTHERWISE NOTED.

#### **MECHANICAL NOTES:**

- 1. DUCTWORK SHOWN INDICATES GENERAL LAYOUT REQUIREMENTS. SHOP DRAWINGS SHALL INDICATE ADDITIONAL DUCT OFFSETS, DROPS, RISES, ETC. REQUIRED TO FIT SPACE AVAILABLE. MECHANICAL CONTRACTOR SHALL COORDINATE WITH FIRE SPRINKLER CONTRACTOR AND ELECTRICAL CONTRACTOR TO ENSURE ADEQUATE SPACE IS AVAILABLE FOR SPRINKLER PIPES AND LIGHTS.
- 2. ALL DUCT DIMENSIONS ARE INSIDE DIMENSIONS: INCREASE DUCT DIMENSIONS TO COMPENSATE FOR DUCT LINER AND WRAP INSULATION THICKNESS.
- 3. TURNING VANES OR EXTRACTORS SHALL BE INSTALLED IN ALL CHANGES IN DIRECTION OF AIR FLOW, WHICHEVER IS APPLICABLE.
- 5. ALL FLEXIBLE DUCTS SHALL BE WIRE REINFORCED WITH MINIMUM 1" THICK INSULATION AND MAXIMUM 5'-0" LENGTH WITH BELL MOUTH TAP.
- 6. ALL PENETRATIONS OF REQUIRED FIRE RATED WALLS, PARTITIONS AND FLOORS SHALL BE PROVIDED WITH FIRE STOPPING MATERIAL PER UBC.
- ENTIRE HVAC SYSTEM SHALL HAVE SEISMIC RESTRAINTS INCLUDING HANGERS. VIBRATION ISOLATION AND FLEXIBLE CONNECTIONS. REFER TO VIBRATION ISOLATION DETAILS.
- 8. CONTRACTOR SHALL PROVIDE DIELECTRIC UNIONS AT CONNECTION POINT FOR ALL DISSIMILAR PIPING.
- 9. SOLDERING FLUX AND SOLDER SHALL NOT CONTAIN LEAD. SOLDERING FLUX SHALL BE NON-CORROSIVE. SELF-CLEANING SOLDER FLUX SHALL NOT BE
- 10. CONDENSATE DRAIN PIPE INSULATION SHALL BE RIGID FIBERGLASS WITH VAPOR BARRIFR.
- 11. AIR CONDITIONING CONTRACTOR SHALL INSULATE ALL PIPING THAT COLLECTS CONDENSATE INCLUDING WASTE PIPE, ETC. FROM POINT OF CONNECTION TO TOP OF CONCRETE FLOOR SLAB ON GRADE.

#### FIRE PROTECTION NOTES:

- 1. PROVIDE COMPLETE WET PIPE FIRE SPRINKLER PROTECTION FOR ENTIRE AREA OF WORK PER NFPA 13 AND IBC, INCLUDING EXPOSED OR FINISHED CEILING SPACE, OCCUPIED OR UNOCCUPIED ROOM.
- 2. OCCUPANCY HAZARD CLASSIFICATION SHALL BE IN ACCORDANCE WITH NFPA 13, EXCEPT THAT UNASSIGNED AND LOFT SPACES SHALL BE CLASSIFIED AS ORDINARY HAZARD.
- 3. FIRE PROTECTION CONTRACTOR SHALL COORDINATE WITH MECHANICAL CONTRACTOR AND PLUMBING CONTRACTOR AND OFFSET PIPING TO FIT WORK FROM ALL DISCIPLINES IN SPACE AVAILABLE.
- 4. FIRE SPRINKLER HEADS AND PIPING INDICATED ON FLOOR PLANS ARE INTENDED TO SHOW GENERAL ROUTING OF PIPING AND TO PROVIDE CONTROL OF CEILING APPEARANCE. THEY SHOULD NOT BE INTERPRETED TO MEAN COMPLETE LAYOUT OF SPRINKLER SYSTEM (REFER TO NOTE NO. 1 ABOVE). FIRE SPRINKLER HEAD LOCATIONS SHALL NOT BE ALTERED EXCEPT WITH THE APPROVAL OF THE ARCHITECT AND ENGINEER.
- 5. WHERE FIRE SPRINKLER HEADS ARE NOT SHOWN, THE CONTRACTOR SHALL DESIGN AND INSTALL A COMPLETE LAYOUT OF FIRE SPRINKLER HEADS TO PROVIDE AN EFFICIENT LAYOUT AND COVERAGE.
- 6. PENETRATIONS OF REQUIRED FIRE RATED WALLS. PARTITIONS AND FLOORS SHALL BE PROVIDED WITH FIRE STOPPING MATERIAL PER IBC.
- 7. EXPOSED PIPING SHALL PROVIDE MAXIMUM HEADROOM CLEARANCE. OFFSET SHALL BE PROVIDED TO ACHIEVE MAXIMUM HEADROOM CLEARANCE.
- 8. PROVIDE SEISMIC PROTECTION FOR PIPING TO PREVENT DAMAGE FROM EARTHQUAKES PER BUILDING CODE.

#### CONSTRUCTION SHUTDOWN NOTES

- 1. [
- ALL OUTAGES TO THE FIRE PROTECTION AND AIR CONDITIONING SYSTEM SHALL BE COORDINATED WITH THE FACILITY MANAGEMENT AND CONTRACTING OFFICER. SUBMIT A REQUEST FOR ANY OUTAGES WITH THE FACILITY MANAGEMENT AND CONTRACTING OFFICER 15 DAYS PRIOR TO THE OUTAGE DATE. OBTAIN WRITTEN
- PIPES UPSTREAM AND DOWNSTREAM OF THE POINTS OF CONNECTION TO MINIMIZE WATER SYSTEM OUTAGES.

#### **LEGEND:**

DEMOLITION A	ND INSTALLAT	TON OF THE N	EW FIRE PROTE	CTION, AND AIR
CONDITIONING	PIPING SYST	EM SHALL BE	ACCOMPLISHED	WITH MINIMAL
INTERRUPTION	TO THE FAC	ILITY.		

- APPROVAL AT LEAST 48 HOURS PRIOR TO THE SHUTDOWN.
- CONTRACTOR SHALL FREEZE EXISTING FIRE SPRINKLER AND CHILLED WATER

	, w ·	ABOVE THUGHED TEOUR
	AHU	AIR HANDLING UNIT
	AP	ACCESS PANEL
	CD	CEILING DIFFUSER
— D ———	CDR	CONDENSATE DRAIN
— CHR ———	CHR	CHILLED WATER RETURN
— CHS ———	CHS	CHILLED WATER SUPPLY
	CHW	CHILLED WATER
	CONN	CONNECT OR CONNECTION
	CONT	CONTINUATION

DOOR LOUVER DOWN

AIR CONDITIONING

ABOVE FINISHED FLOOR

FLXC FLEXIBLE CONNECTOR FRD FIRE DAMPER GENERAL CONTRACTOR

EXISTING

OUTSIDE AIR CONCEALED TYPE PENDENT FIRE SPRINKLER HEAD

POINT OF CONNECTION


SUPPLY REGISTER

RETURN AIR RETURN REGISTER SUPPLY AIR

TERMINATE TG TRANSFER GRILLE

**VOLUME DAMPER** 



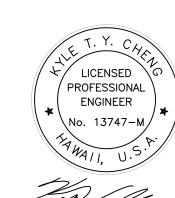


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LICENSE EXPIRATION DATE: 04/30/16

DSGN.	DRWN.	CHKD.	APPD.
RA	RA	KC	KC

KEY PLAN / NOTES

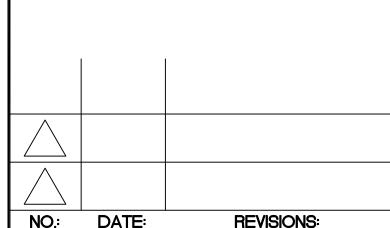

#### PROJECT TITLE:

MINOR REPAIR AT VIDEO ROOM, HNL HONOLULU INTERNATIONAL **AIRPORT** HONOLULU, HAWAII

#### PROJECT NO.:


STATE PROJECT NO. CO1630-33


#### SHEET TITLE:

HVAC GENERAL NOTES. MECHANICAL NOTES AND LEGEND

DATI	E:		
3/31	/16		
DWG	ì. NO.:		
9	OF	14	

**M-1** 

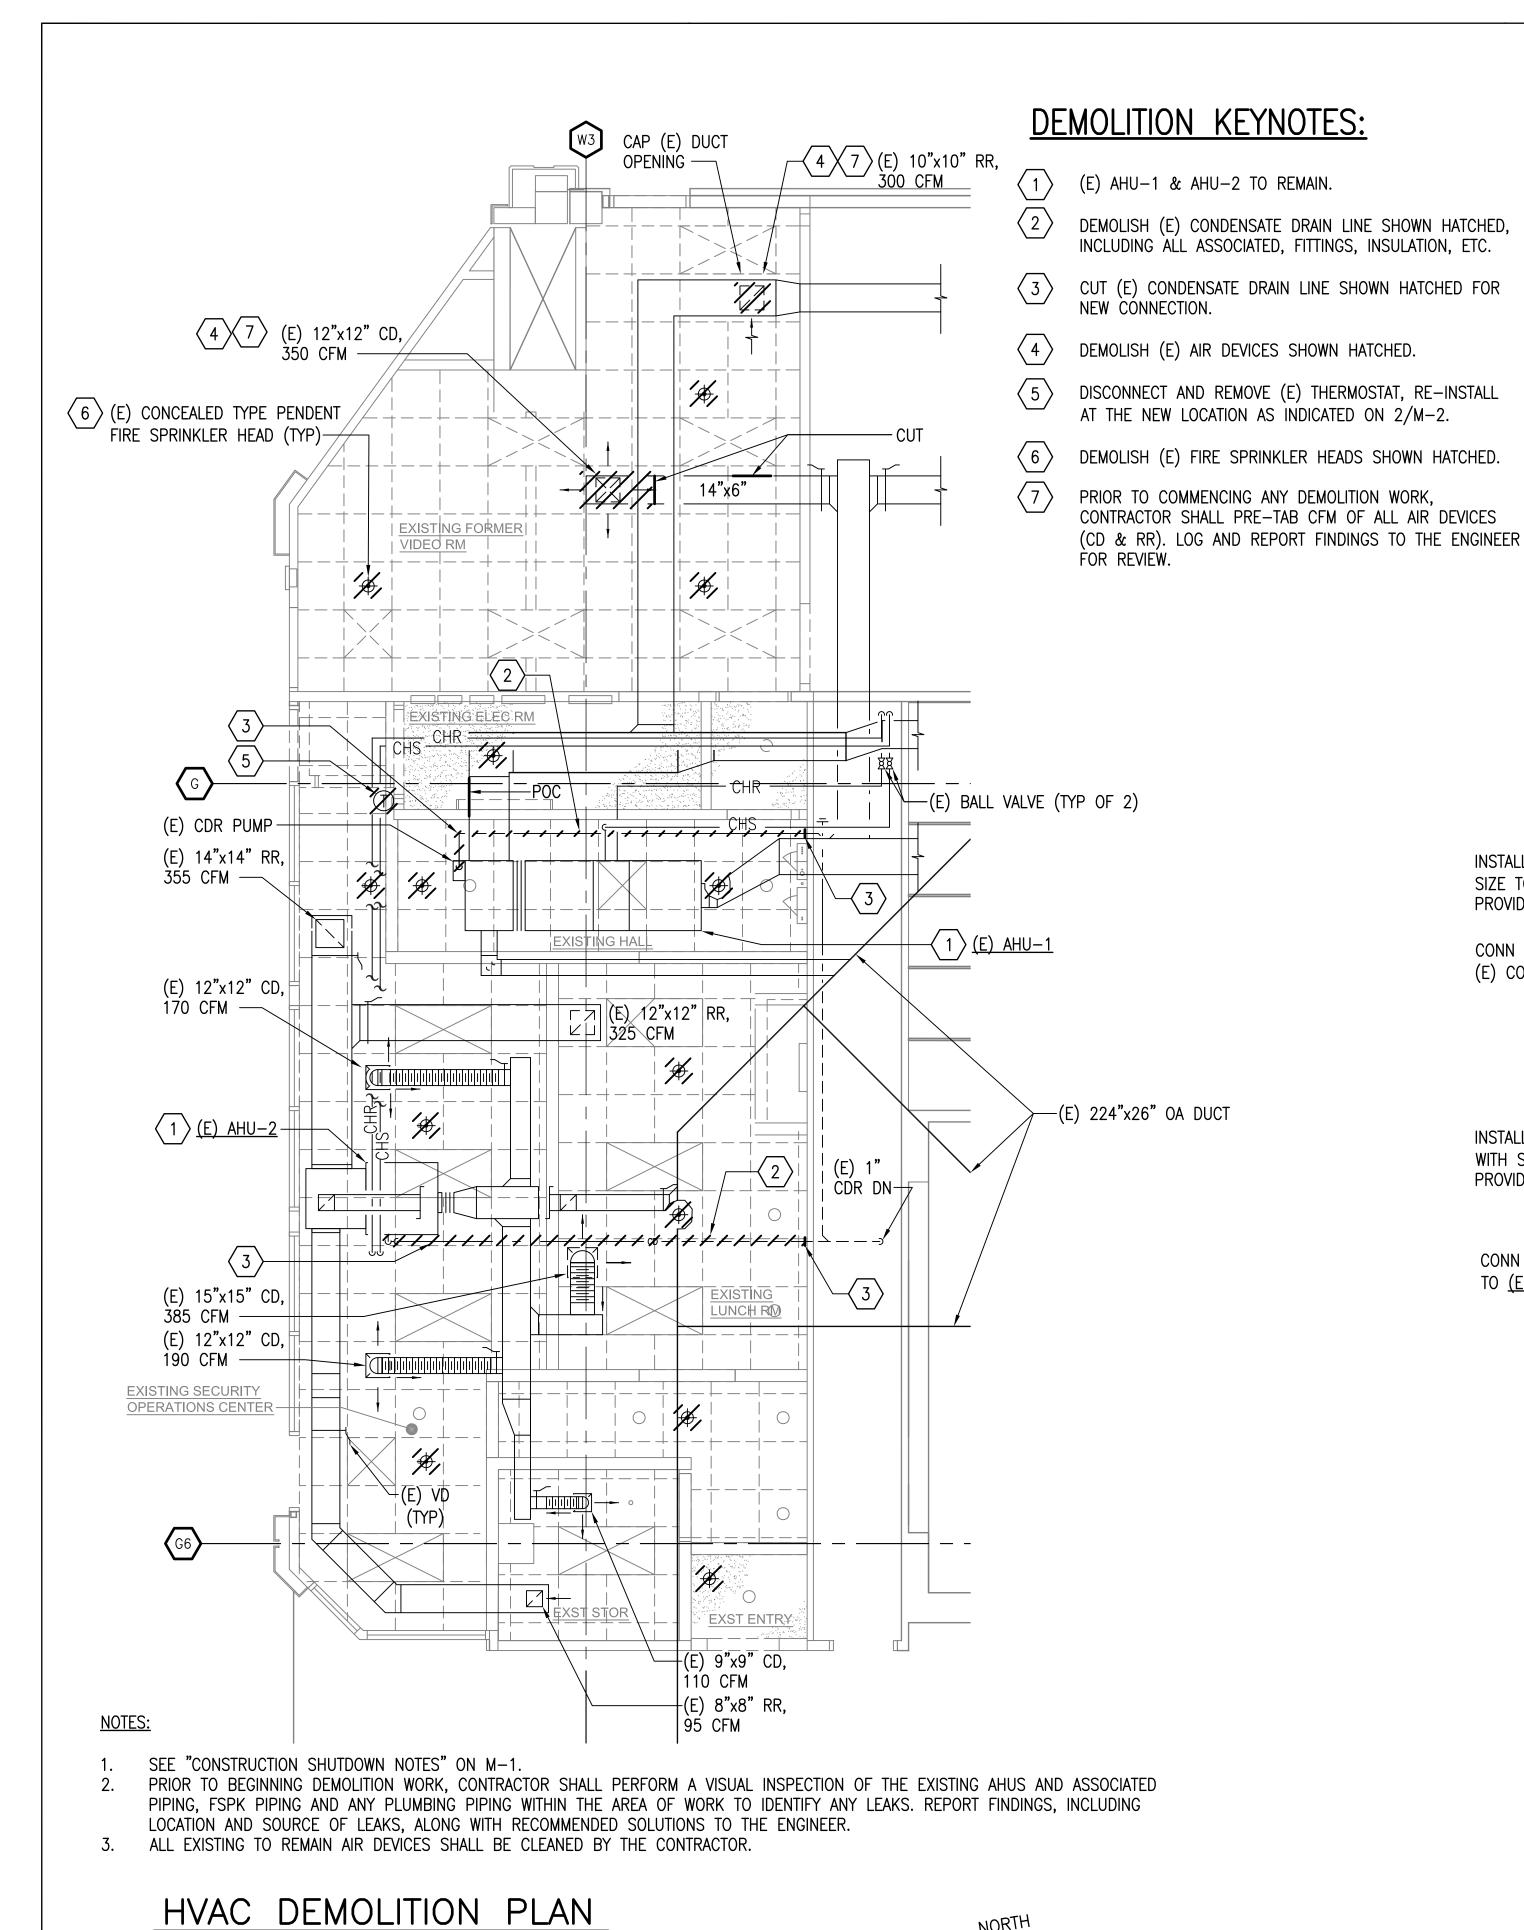

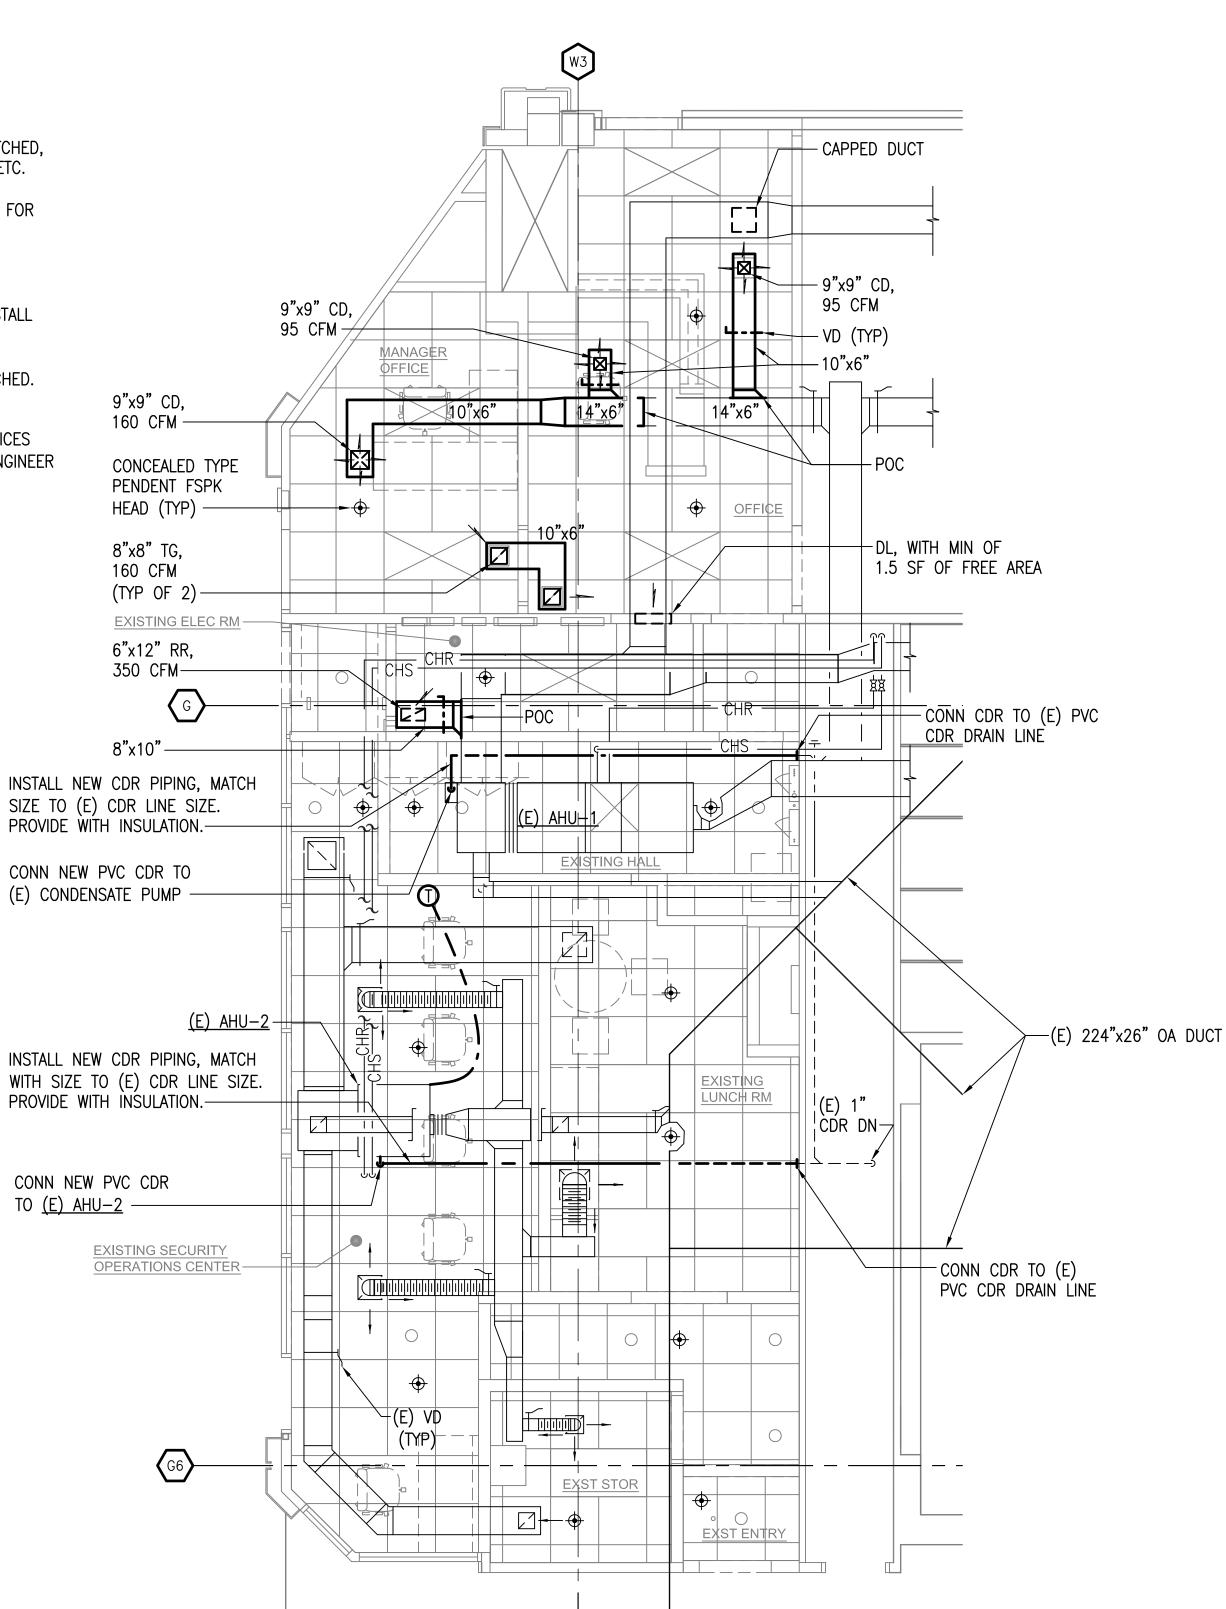


SEE CONSTRUCTION SHUTDOWN NOTES ON M-1.

NOTES:

ALL NEW FSPK HEADS SHALL BE INSTALLED IN ACCORDANCE WITH NFPA 13 REQUIREMENTS.

HVAC RENOVATION PLAN HNL SECURITY VIDEO RM - LEVEL 2



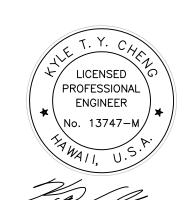


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#### PROJECT NO.:

STATE PROJECT NO. CO1630-33

#### SHEET TITLE:

HVAC DEMOLITION AND HVAC RENOVATION PLANS

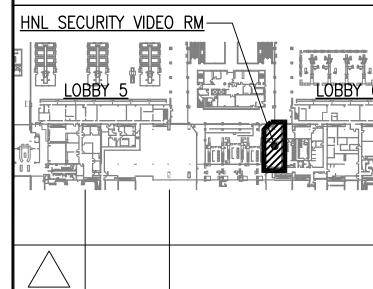DATE: 3/31/16 DWG. NO.:


<u>10</u> OF <u>14</u>


**M-2** 

HNL SECURITY VIDEO RM - LEVEL 2

SCALE: 1/4"=1'-0"

SCALE: 1/4"=1'-0"

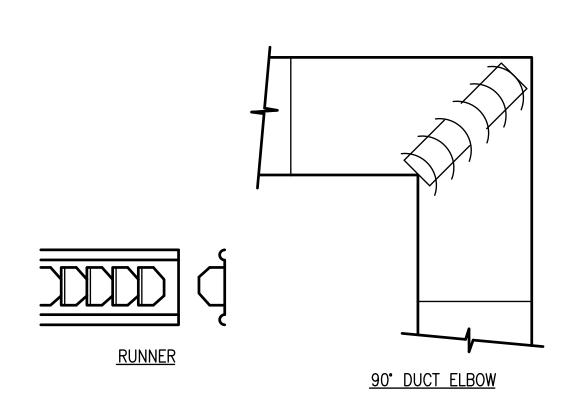

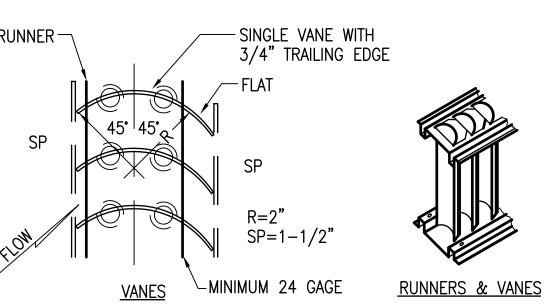


NOTE

ALL RECTANGULAR DUCTS SHALL HAVE SQUARE ELBOWS WITH TURNING VANES UNLESS INDICATED DIFFERENTLY ON PLANS.


1 DUCT ELBOW DETAILS

NOT TO SCALE

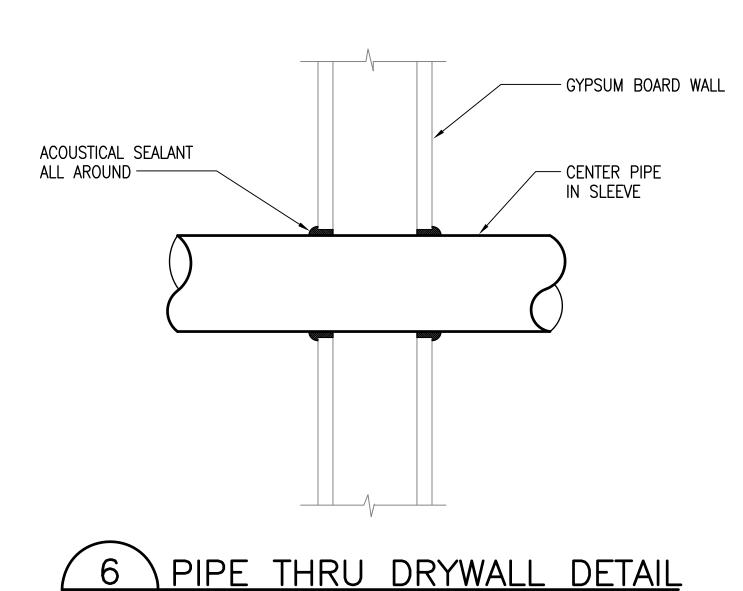


NOT TO SCALE

M-3

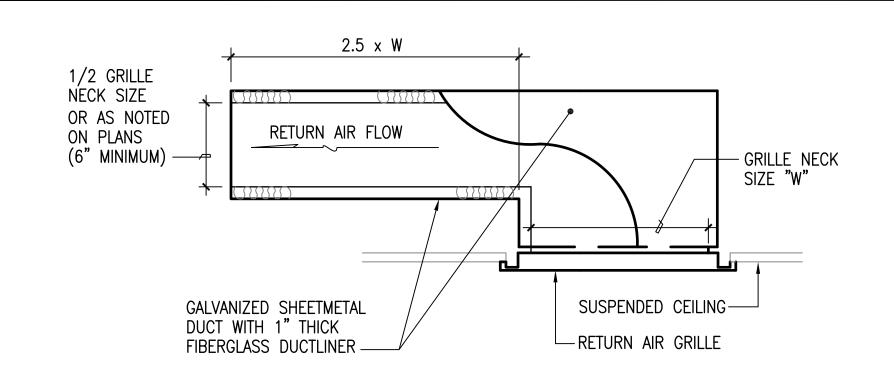


2 RETURN AIR GRILLE AND SUB DUCT DETAIL
M-3 NOT TO SCALE (TRANSFER GRILLE SIMILAR

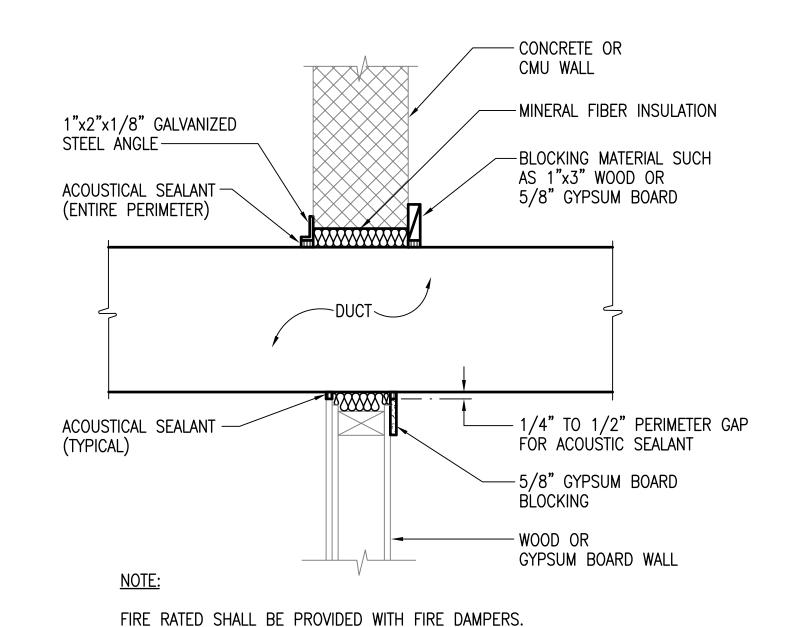

WALL OPENING CLOSURE ANGLE SHALL BE IN ACCORDANCE WITH FIRE DAMPER UL LISTING.


\TYPICAL DUCT THRU WALL DETAIL

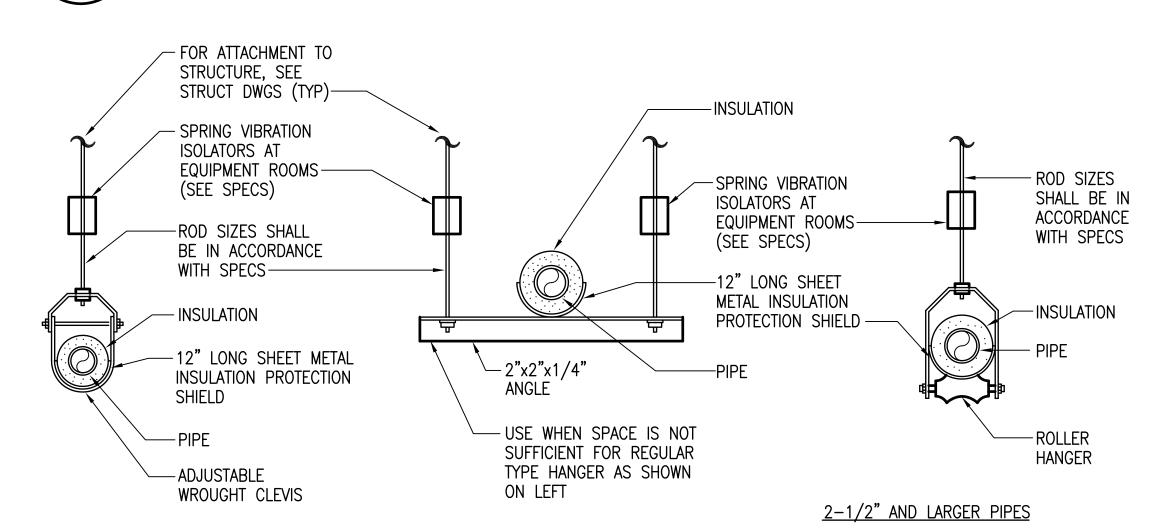

2" AND SMALLER PIPES


NOTE: 18" LONG RIGID INSULATION SHALL BE USED AT HANGERS



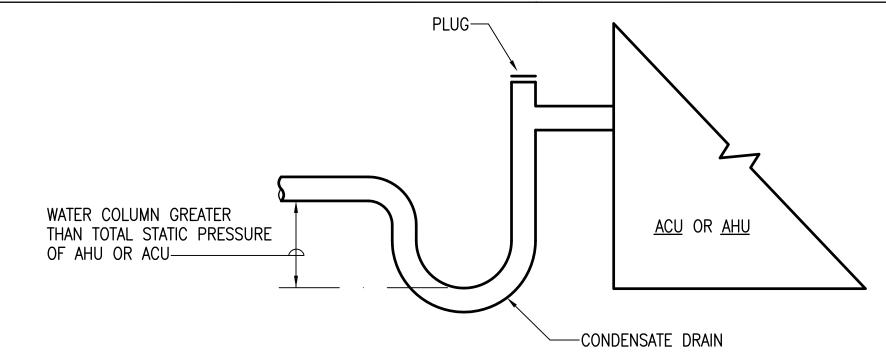

3 CONDENSATE DRAIN CONNECTION DETAIL

NOT TO SCALE

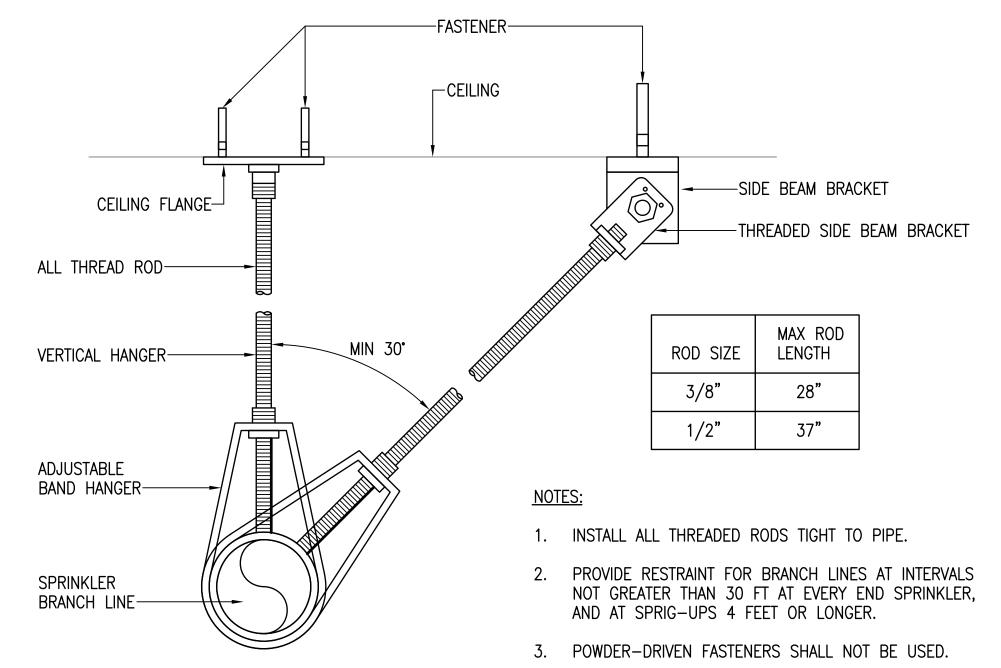

5 BRANCH LINE RESTRAINT DETAIL

NOT TO SCALE



Airports Divisio




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PROJECT NO. :

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SHEET TITLE :


MECHANICAL DETAILS

DATE	<b>:</b>		
3/31	/16		
DWG	i. NO.:		
11	OF	14	

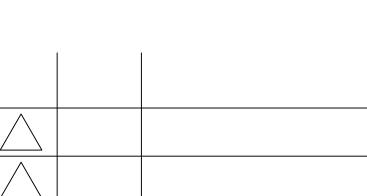**M-3** 

### ELECTRICAL SYMBOL LIST

	HEIGHT OOR TO	,		IDICATED ON PLAN)		
TOP ¢		SYMBOL EXISTING NEW		DESCRIPTION		
				LUMINAIRE, CEILING MOUNTED (NUMERAL IN CIRCLE CORRESPONDS TO LUMINAIRE SCHEDULE)		
				LUMINAIRE, CEILING MOUNTED WITH EMERGENCY BATTERY PACK (NUMERAL IN CIRCLE CORRESPONDS TO LUMINAIRE SCHEDULE)		
		$\bigcirc$		LUMINAIRE, CEILING MOUNTED (NUMERAL IN CIRCLE CORRESPONDS TO LUMINAIRE SCHEDULE)		
				LUMINAIRE, WALL MOUNTED		
	46"	<del>{}</del>	\$ª	LIGHT SWITCH, FLUSH MOUNTED (LETTER INDICATES LUMINAIRES CONTROLLED)		
18"		€}=	<del></del>	RECEPTACLE, DUPLEX, GROUNDING TYPE, 125V, NEMA 5-20R		
		——е——		CONCEALED CONDUIT IN CEILING OR WALLS		
		-е		CONCEALED CONDUIT BELOW GRADE OR IN FLOOR SLAB		
		- — -e- — -		SURFACE MOUNTED CONDUIT OR SURFACE METAL RACEWAY		
				SURFACE MOUNTED CONDUIT, SUPPORTS PER NEC		
			J	JUNCTION BOX, HORIZONTALLY MOUNTED		
		(J)H	<u>ال</u>	JUNCTION BOX, WALL MOUNTED		
		[]		PANELBOARD		
			A-1,3	HOMERUN ARROW TO PANELBOARD. LETTER INDICATES PANELBOARD, NUMBERS INDICATES CIRCUITS		
	18"		$\Diamond$	INFORMATION OUTLET, FLUSH WALL MOUNTED, 4 11/16" x 2 1/8" DEEP OUTLET BOX WITH DOUBLE-GANG REDUCER AND DOUBLE GANG COVER PLATE		
	46"	[F]H		FIRE ALARM MANUAL STATION		
	82"	[>[F]H	DFH	FIRE ALARM NOTIFICATION APPLIANCE		
			X	DENOTES DEMOLITION/REMOVAL		
			+42"	DENOTES 42" ABOVE FINISHED FLOOR OR GRADE		
			GND	GROUND		
			1)—	NOTE INDICATOR		
			1 E-2	DETAIL INDICATOR: TOP HALF DENOTES DETAIL NUMBER, BOTTOM HALF DENOTES SHEET NUMBER		

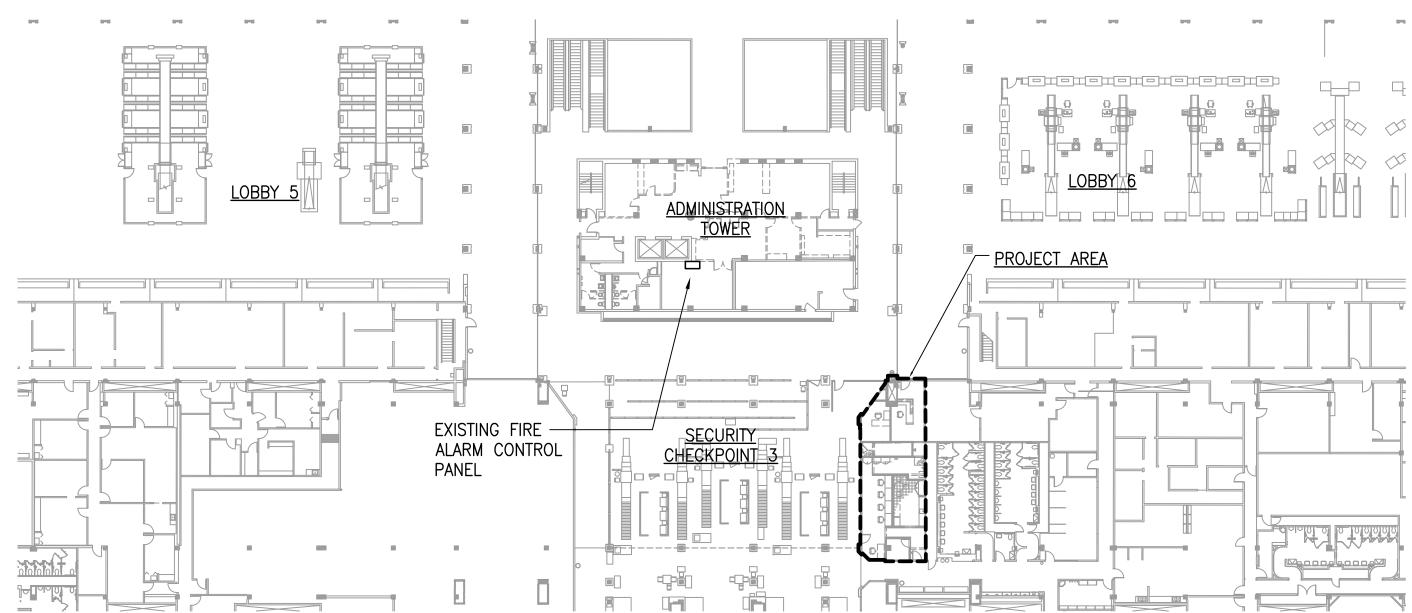

## PARTIAL MAIN TERMINAL PLAN SCALE: 1/32" = 1'-0"

#### **GRAPHIC SCALE**

1/32" = 1'-0"

10' 0 20' 40' 60' 80' 100' 120' 140'

**GENERAL ELECTRICAL NOTES:** 

- 1. ELECTRICAL WORK SHALL BE PERFORMED IN ACCORDANCE WITH THE LATEST EDITION OF THE NATIONAL ELECTRICAL CODE (NEC), NATIONAL ELECTRICAL SAFETY CODE, AND ALL LOCAL RULES AND REGULATIONS.
- 2. THE CONTRACTOR SHALL VISIT THE JOB SITE AND FAMILIARIZE HIMSELF WITH ALL EXISTING CONDITIONS AND THE EXTENT OF REMOVAL, RELOCATION, RECONNECTION AND/OR NEW WORK PRIOR TO BIDDING. BID SUBMISSION SHALL BE CONSIDERED AS EVIDENCE THAT THE CONTRACTOR HAS VISITED THE SITE AND RESOLVED ALL DISCREPANCIES AND QUESTIONS AND NO EXTRA PAYMENT WILL BE AUTHORIZED FOR WORK MADE NECESSARY BY THE CONTRACTOR'S FAILURE TO DO SO.
- 3. EXISTING DEVICE LOCATIONS, CIRCUIT ASSIGNMENTS, WIRING CONNECTIONS AND CONDUIT RUNS INDICATED WERE DERIVED FROM AVAILABLE REFERENCE DOCUMENTS AND LIMITED FIELD INVESTIGATION. FIELD VERIY ALL EXISTING CONDITIONS AND MAKE ANY NECESSARY ADJUSTMENTS TO SATISFY THE INTENT OF THE DRAWINGS AND SPECIFICATIONS.
- 4. ALL CIRCUITS SHALL INCLUDE AN INSULATED GREEN GROUNDING CONDUCTOR, SIZED PER THE NATIONAL ELECTRICAL CODE. THIS CONDUCTOR SHALL BE CARRIED IN ALL RACEWAYS AND SHALL BE ATTACHED TO THE DEVICE OR EQUIPMENT HOUSING USING A SUITABLE GROUNDING LUG.
- 5. WORK INCIDENTAL TO THE CONTRACT AND NECESSARY TO COMPLETE THE PROJECT, ALTHOUGH NOT SPECIFICALLY REFERRED TO ON THE CONTRACT DOCUMENTS, SHALL BE FURNISHED AND PERFORMED BY THE CONTRACTOR.
- 6. IN PERFORMING ALL WORK, THE CONTRACTOR SHALL EXERCISE DUE CARE AND CAUTION NECESSARY TO AVOID ANY DAMAGE TO AND IMPAIRMENT IN THE USE OF ANY EXISTING UTILITY LINES. ANY DAMAGE INFLICTED ON EXISTING UTILITY LINES RESULTING FROM THE CONTRACTOR'S OPERATIONS SHALL BE IMMEDIATELY REPAIRED OR RESTORED AS DIRECTED BY THE STATE AT THE CONTRACTOR'S EXPENSE.
- 7. THE CONTRACTOR AGREES THAT HE SHALL ASSUME SOLE AND COMPLETE RESPONSIBILITY FOR THE JOB SITE CONDITIONS DURING THE COURSE OF CONSTRUCTION OF THIS PROJECT, INCLUDING THE SAFETY OF ALL PERSONS AND PROPERTY; THAT THIS REQUIREMENT SHALL APPLY CONTINUOUSLY AND NOT BE LIMITED TO NORMAL WORKING HOURS.
- 8. SHOULD PROJECT CONDITIONS REQUIRE REARRANGEMENT OF WORK, THE CONTRACTOR SHALL MARK SUCH CHANGES ON THE AS-BUILT DRAWINGS. IF THESE CHANGES REQUIRE ALTERNATE METHODS TO THOSE SPECIFIED IN THE CONTRACT DRAWINGS, THE CONTRACTOR SHALL SUBMIT DRAWINGS TO REFLECT THE PROPOSED ALTERNATE METHODS TO THE UNIVERSITY. THE CONTRACTOR SHALL NOT PROCEED UNTIL APPROVAL IS OBTAINED. REARRANGEMENT OF WORK FOR THE PURPOSE OF COORDINATION SHALL NOT BE CONSIDERED AN ITEM FOR EXTRA COST.
- 9. MAINTAIN CONTINUITY OF ALL EXISTING CIRCUITS TO AREAS AND SYSTEMS OUTSIDE OF THE PROJECT LIMITS AND THAT PASS THROUGH THE PROJECT LIMITS. PROVIDE NEW JUNCTION BOXES, CONDUITS AND WIRING, AND THE LABOR REQUIRED TO FACILITATE SAID CONTINUITY. BOXES, CONDUITS AND WIRING SHALL BE IN ACCORDANCE WITH THE NEC.
- PRIOR TO COMMENCING ANY WORK ON THE EXISTING FIRE ALARM SYSTEM, CONFIRM THAT THE SYSTEM IS OPERATING PROPERLY BY TESTING THE SYSTEM IN THE PRESENCE OF THE STATE'S DESIGNATED REPRESENTATIVE OR OBTAINING CLEARANCE FROM THE STATE. ANY PRE-EXISTING DEFICIENCIES SHOULD BE NOTED AT THAT TIME AND PRESENTED TO THE STATE FOR THEIR ACTION. THE CONTRACTOR WILL BE RESPONSIBLE FOR REPAIRING ANY ENSUING SYSTEM DEFICIENCIES NOT DOCUMENTED DURING THE PRELIMINARY TESTING/CONFIRMATION PERIOD AT NO ADDITIONAL COST TO THE PROJECT.

#### FIRE SAFETY NOTES:

- I. STRUCTURES UNDERGOING CONSTRUCTION, ALTERATIONM OR DEMOLITION OPERATIONS, INCLUDING THOSE IN UNDERGROUND LOCATIONS, SHALL COMPLY WITH NFPA 241, STANDARD FOR SAFEGUARDING, CONSTRUCTION, ALTERATION, AND DEMOLITION OPERATIONS, AND NFPA 1 2012, AS AMENDED.
- 2. FIRE SAFETY DURING ALTERATION:
  - a. 16.4.4.1 WHERE THE BUILDING IS PROTECTED BY FIRE PROTECTION SYSTEMS, SUCH SYSTEMS SHALL BE MAINTAINED OPERATIONAL AT ALL TIMES DURING ALTERATION.
  - b. 16.4.4.2 WHERE ALTERATION REQUIRES MODIFICATION OF A PORTION OF THE FIRE PROTECTION SYSTEM, THE REMAINDER OF THE SYSTEM SHALL BE KEPT IN SERVICE AND THE FIRE DEPARTMENT SHALL BE NOTIFIED.
  - c. 16.4.4.3 WHEN IT IS NECESSARY TO SHUT DOWN THE SYSTEM, THE AHJ SHALL HAVE THE AUTHORITY TO REQUIRE ALTERNATE MEASURES OF PROTECTION UNTIL THE SYSTEM IS RETURNED TO SERVICE.
  - d. 10.8.1.1 AS NECESSARY DURING EMERGENCIES, MAINTENANCE, DRILLS, PRESCRIBED TESTING, ALTERATIONS, OR RENOVATIONS, PORTABLE OR FIXED FIRE—EXTINGUISHING SYSTEMS OR DEVICES OR ANY FIRE—WARNING SYSTEM SHALL BE PERMITTED TO BE MADE INOPERATIVE OR INACCESSIBLE. A FIRE WATCH SHALL BE REQUIRED AS SPECIFIED IN SECTIONS 13.3.3.6.5.2(4)(b), 13.7.1.4.4, 16.5.4, 34.6.3.3, 41.2.2.6, 41.2.2.7, 41.2.4, 41.3.5, 41.4.1, 34.5.4.3, AND 25.1.8 AT NO COST TO THE AHJ. NFPA 1 2012, AS AMENDED.

#### LUMINAIRE SCHEDULE

TYPE

DESCRIPTION

LAMPS

LED, RECESSED 2' X 4', DIE FORMED COLD ROLLED STEEL HOUSING, NOMINAL
6,800 LUMINAIRE LUMENS, NOMINAL 102 LUMENS PER WATT, 4" MAXIMUM DEPTH,
K12 PRISMATIC LENS, 277V DRIVER, 1400 LUMEN EMERGENCY BATTERY PACK
WHERE INDICATED.
COLUMBIA #LJT24-35-VLG-FSA12125-EU-PAF-(ELL14) OR APPROVED EQUIVALENT



Airports Division
DEPARTMENT OF TRANSPORTATION




This work was prepared by me or under my supervision and construction of the project will be under my observation. Expiration date 04/30/16.

LICENSE EXPIRATION DATE: 04/30/16

DSGN.	DRWN.	CHKD.	APPD.
MA	IP	MA	MA

KEY PLAN / NOTES :

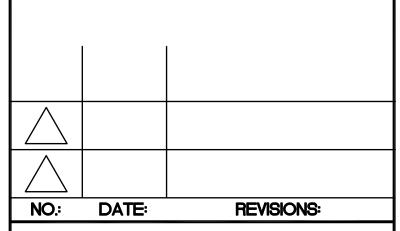

#### PROJECT TITLE:

MINOR REPAIR AT VIDEO ROOM, HNL HONOLULU INTERNATIONAL AIRPORT HONOLULU, HAWAII

PROJECT NO.:

STATE PROJECT NO. CO1630-33

SHEET TITLE :

ELECTRICAL SYMBOL LIST, NOTES AND LUMINAIRE SCHEDULE

DATE	<b>:</b>		
3/31	/16		
DWG	. NO.:		
12	OF	<u>14</u>	

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